PROJECT INFORMATION

SCOPE OF WORK:

REMOVE AND REPLACE (2) EXISTING ANTENNAS WITH (2) NEW ANTENNAS AND ADD (1) NEW ANTENNA. INSTALL (2) STEALTH CHIMNEY FIBERGLASS ENCLOSURES, INSTALL TWO EQUIPMENT

CABINETS ON AN EXISTING CURB. ADD ELECTRICAL & FIBER

SITE ADDRESS:

25 WEBSTER AVENUE SOMERVILLE, MA 02143

PROPERTY OWNER:

IPC LOUISVILLE PROPERTIES LLC 303 NORTH HURSTBOURNE PARKWAY

LOUISVILLE, KY 40222

LATITUDE:

42° 22' 41.88" N (NAD 83)*

LONGITUDE:

71° 05' 47.04" W (NAD 83)* * PER RF DATA SHEETS

JURISDICTION:

CITY OF SOMERVILLE

CURRENT USE: PROPOSED USE: APARTMENT/TELECOMMUNICATIONS FACILITY APARTMENT/TELECOMMUNICATIONS FACILITY

NAME OF APPLICANT:

TITLE SHEET

ROOF PLAN

500' RADIUS PLAN

SOUTH & EAST ELEVATIONS

NORTH & WEST ELEVATIONS

AT&T MOBILITY 550 COCHITUATE ROAD SUITES 13 & 14 FRAMINGHAM, MA 01701

DRAWING INDEX

REV

2

at&t Mobility

2011 APR 27 PM 5: 14

RECEIVED S.P.C.D. AND PLANNING DEPT.

SITE NAME: WEBSTER COURT SITE NUMBER: 2242

VICINITY MAP

DIRECTIONS: TAKE THE 1-90 E/MASS. PIKE TOWARD BOSTON ONTO 1-90 E. TAKE EXIT 18 ON THE LEFT TOWARD CAMBRIDGE ONTO CAMBRIDGE ST. CONTINUE ON RIVER ST BRIDGE/R ST BRIDGE. CONTINUE TO FOLLOW R ST BRIDGE. CONTINUE ON RIVER ST. CONTINUE ON PROSPECT ST. TURN LEFT SOMERVILLE AVE. CONTINUE ON UNION SQUARE. TURN LEFT AT WEBSTER AVE. THE SITE WILL BE

SITE LOCATION: 25 Webster Ave Somerville, MA 02143 Somerville

APPLICABLE BUILDING CODES AND STANDARDS

CONTRACTOR'S WORK SHALL COMPLY WITH PROJECT STANDARD NOTES, SYMBOLS AND DETAILS (SEE DRAWING INDEX FOR STANDARD NOTES AND DETAILS INCLUDED WITH TYPICAL DRAWING PACKAGE).
CONTRACTOR WORK SHALL COMPLY WITH ALL APPLICABLE NATIONAL, STATE, AND LOCAL CODES AS
ADOPTED BY THE LOCAL AUTHORITY HAVING JURISDICTION (AHJ) FOR THE LOCATION. THE EDITION OF THE AHJ ADOPTED CODES AND STANDARDS IN EFFECT ON THE DATE OF CONTRACT AWARD SHALL GOVERN THE DESIGN.

BUILDING CODE:

MASSACHUSETTS STATE BUILDING CODE (780 CMR)

NATIONAL ELECTRICAL CODE (NEC 2011) MASSACHUSETTS ELECTRICAL CODE (527 CMR 12.00)

CONTRACTOR'S WORK SHALL COMPLY WITH THE LATEST EDITION OF THE FOLLOWING STANDARDS. AMERICAN CONCRETE INSTITUTE (ACI) 318, BUILDING CODE REQUIREMENTS FOR STRUCTURAL CONCRETE AMERICAN INSTITUTE OF STEEL CONSTRUCTION (AISC), MANUAL OF STEEL CONSTRUCTION, ASD, NINTH

TELECOMMUNICATIONS INDUSTRY ASSOCIATION (TIA) 222-G, STRUCTURAL STANDARDS FOR STEEL ANTENNA TOWER AND ANTENNA SUPPORTING STRUCTURES: TIA 607, COMMERCIAL BUILDING GROUNDING AND BONDING REQUIREMENTS FOR TELECOMMUNICATIONS

INSTITUTE FOR ELECTRICAL AND ELECTRONICS ENGINEERS (IEEE) 81, GUIDE FOR MEASURING EARTH RESISTIVITY, GROUND IMPEDANCE, AND EARTH SURFACE POTENTIALS OF A GROUND SYSTEM IEEE 1100 (1999) RECOMMENDED PRACTICE FOR POWERING AND GROUNDING OF ELECTRONIC FOUIPMENT

IEEE C62.41, RECOMMENDED PRACTICES ON SURGE VOLTAGES IN LOW VOLTAGE AC POWER CIRCUITS (FOR LOCATION CATEGORY "C3" AND "HIGH SYSTEM EXPOSURE")

TELCORDIA GR-1503, COAXIAL CABLE CONNECTIONS

ANSI T1.311, FOR TELECOM - DC POWER SYSTEMS - TELECOM, ENVIRONMENTAL PROTECTION

FOR ANY CONFLICTS BETWEEN SECTIONS OF LISTED CODES AND STANDARDS REGARDING MATERIAL, METHODS OF CONSTRUCTION, OR OTHER REQUIREMENTS, THE MOST RESTRICTIVE REQUIREMENT SHALL GOVERN. WHERE THERE IS CONFLICT BETWEEN A GENERAL REQUIREMENT AND A SPECIFIC REQUIREMENT, THE SPECIFIC REQUIREMENT SHALL GOVERN

CONTACT & UTILITY INFORMATION

THIS DOCUMENT WAS DEVELOPED TO REFLECT A SPECIFIC SITE AND ITS SITE CONDITIONS AND IS NOT TO BE USED FOR ANOTHER SITE OR WHEN OTHER CONDITIONS PERTAIN. REUSE OF THIS DOCUMENT IS AT THE SOLE

CONTACT **ENGINEERING** SAC:

CONST.:

A01

A02

A03

A04

CONTACT

GREG H. NAWROTZKI DAVE COOPER RICO MARTELL

COMPANY DEWBERRY

SAI COMMUNICATIONS SAI COMMUNICATIONS PHONE NO. (617) 695-3400

(603) 305-5641 (774) 454-3788

1-800-592-2000

UTILITIES

POWER:

TELCO:

NSTAR VERIZON

(800) 941-9900

SITE NO. 2242 25 WEBSTER AVENUE SOMERVILLE, MA 02143

WEBSTER COURT

Mobility 550 COCHITUATE ROAD SUITES 13 & 14

2 04/26/1 ISSUED FOR SUBMITTAL GHN GHN PPB 04/01/11 ISSUED FOR SUBMITTAL GHN GHN PPB 0 03/31/11 ISSUED FOR REVIEW GHN GHN PPB DATE BY CHK APP'D REVISIONS SCALE: AS SHOWN DESIGNED BY: GHN DRAWN BY: MR

BRADFORD A MILLS CIVII No 33966

TH OF MAS

AT&T MOBILITY FRAMINGHAM, MA 01701

TITLE SHEET

DRAWING NUMBER DEWBERRY NO. 50019239/50040702





Dewberry-Goodkind, Inc. 280 SUMMER ST. 10TH FLOOR BOSTON, MA 02210 PHONE: 617.695.3400 FAX: 617.695.3310



22 KEEWAYDIN DRIVE

SALEM. NH 03079

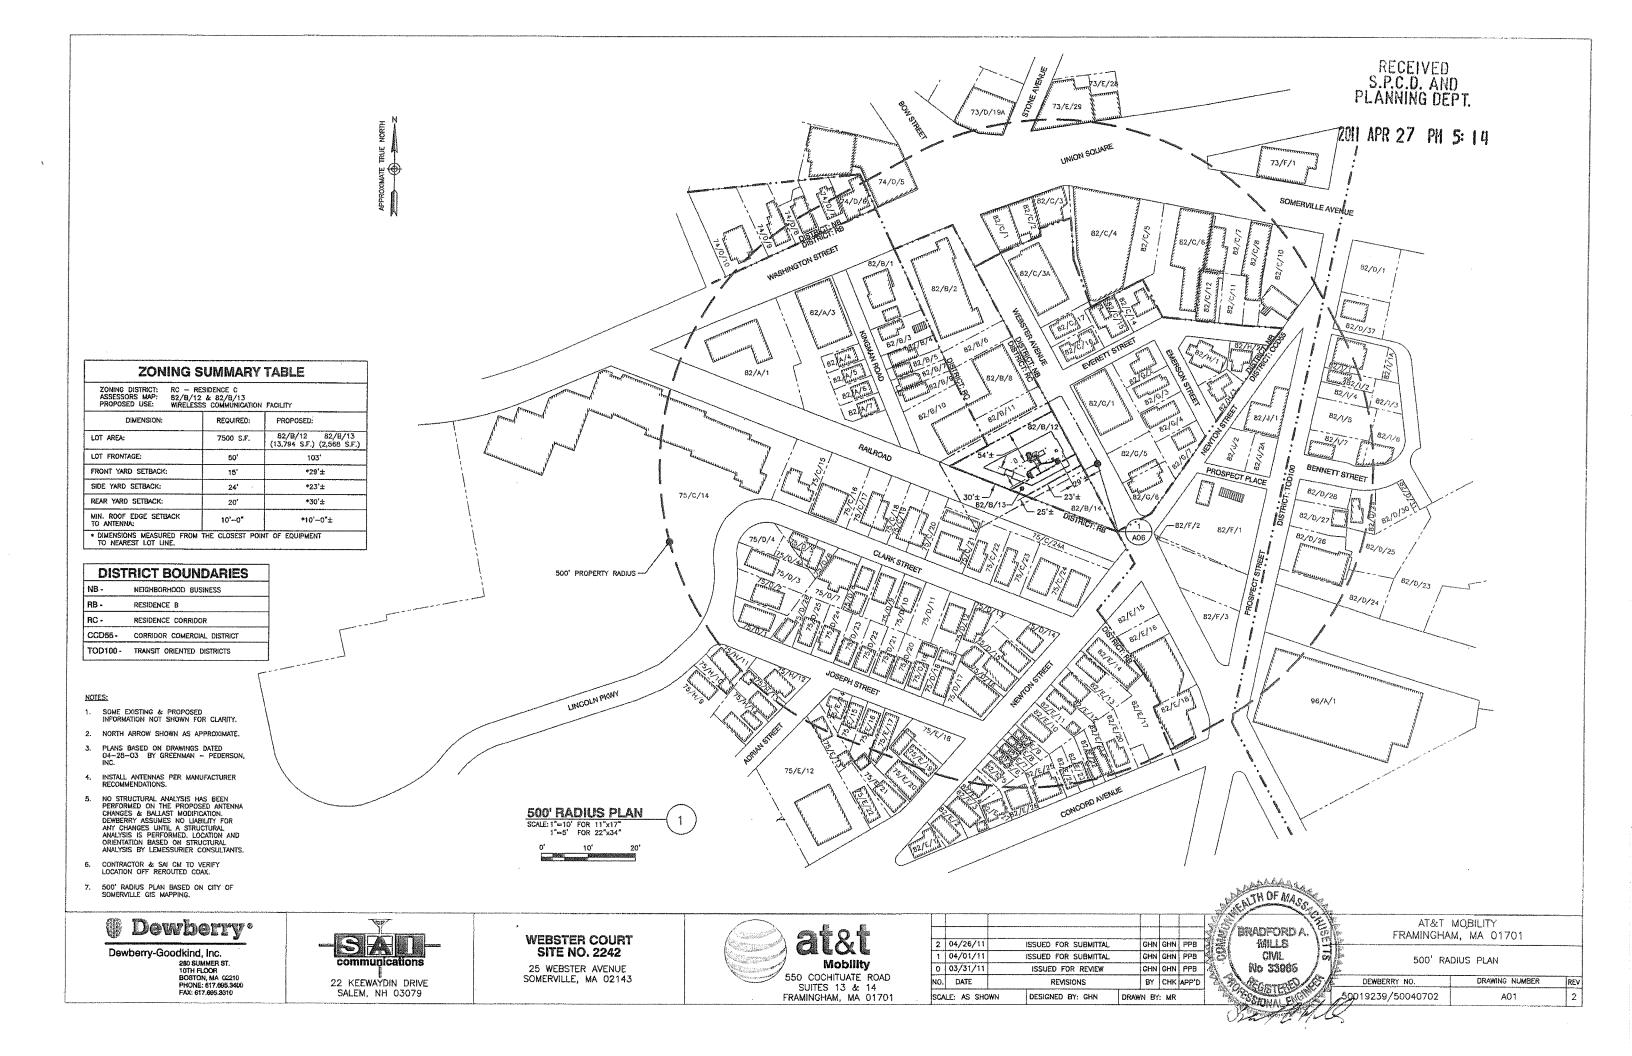

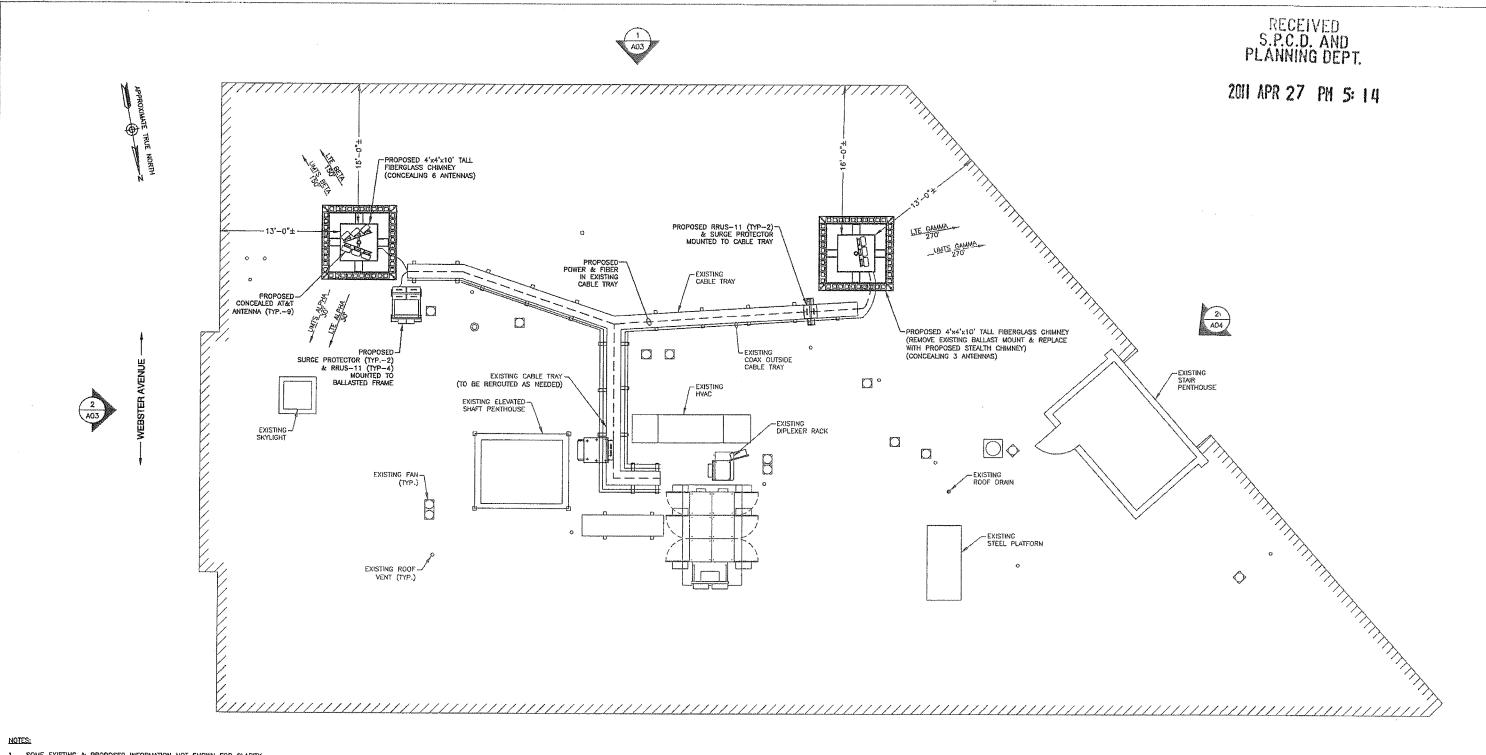

- SOME EXISTING & PROPOSED INFORMATION NOT SHOWN FOR CLARITY.
- 2. NORTH ARROW SHOWN AS APPROXIMATE.
- PLANS BASED ON DRAWINGS DATED 04-28-03 BY GREENMAN PEDERSON, INC.
- INSTALL ANTENNAS PER MANUFACTURER RECOMMENDATIONS.
- 5. NO STRUCTURAL ANALYSIS HAS BEEN PERFORMED ON THE PROPOSED ANTENNA CHANGES & BALLAST MODIFICATION. DEWBERRY ASSUMES NO LABILITY FOR ANY CHANGES UNTIL A STRUCTURAL ANALYSIS IS PERFORMED. LOCATION AND ORIENTATION BASED ON STRUCTURAL ANALYSIS BY LEMESSURIER CONSULTANTS.
- 6. CONTRACTOR & SAI CM TO VERIFY LOCATION OFF REPOUTED COAX.




280 SUMMER ST. 10TH FLOOR BOSTON, MA 02210 PHONE: 817.695.3400 FAX: 617.695.3310



WEBSTER COURT SITE NO. 2242

25 WEBSTER AVENUE SOMERVILLE, MA 02143

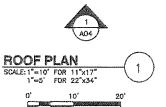

at&t	
550 COCHITUATE ROAD	
SUITES 13 & 14	
FRAMINGHAM, MA 01701	

2	04/26/11	ISSUED FOR SUBMITTAL	GHN	GHN	PPB
1	04/01/11	ISSUED FOR SUBMITTAL	GHN	GHN	PPB
0	03/31/11	ISSUED FOR REVIEW	GHN	GHN	PPB
NO.	DATE	REVISIONS	BY	снк	APP'D
SCA	LE: AS SHO	WN DESIGNED BY: GHN DRAW	VN BY	: MR	

S-2	and the same		
BRADFORD A. MILLS		AT&T MO FRAMINGHAM,	DBILITY MA 01701
CIVIL	3		

LEBELLANCE OF JR OF WAS

CONCEPTUAL	ROOF	PLAN	 OPTION	2	

DEWBER	RY NO.	DRAWING N	NUMBER	REV
50019239	/50040702	A02	2	2

