


#### PREPARED BY:

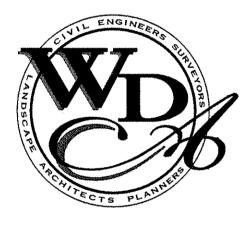

CIVIL ENGINEERING

WATERMAN DESIGN ASSOCIATES, INC.

31 East Main Street
Westborough, MA 01581

508.366.6552
508.366.6506 (FAX)
WATERMANDESIGN.COM WDA@WDASSOC.COM

### OWNERS:

InterNAP
Network Services
70 Inner Belt Road
Somerville, MA 02143

### APPLICANT:

InterNAP
Network Services
70 Inner Belt Road
Somerville, MA 02143

## Special Permit Site Plan Review

Pursuant to Somerville Zoning By-Law, Section 5.2.

FOR

### 50 Inner Belt Road

IN

# Somerville, Massachusetts (Middlesex County)

DATE: August 14, 2008

### SHEET LIST:

C1.01	EXISTING CONDITIONS PLAN
C2.01	SITE PREPARATION & DEMOLITION PLAN
C2.02	LAYOUT AND MATERIALS PLAN
C2.03	GRADING AND DRAINAGE PLAN
C2.04	UTILITY PLAN
C2.05	PLANTING AND LIGHTING PLAN
C3.01-C3.02	DETAILS

FILE NO.: DWG. NO.:

**REGULATORY PERMITTING** 

WETLAND CONSULTING

0671600


0672601A


SURVEYING


• LANDS


YING


LANDSCAPE ARCHITECTURE

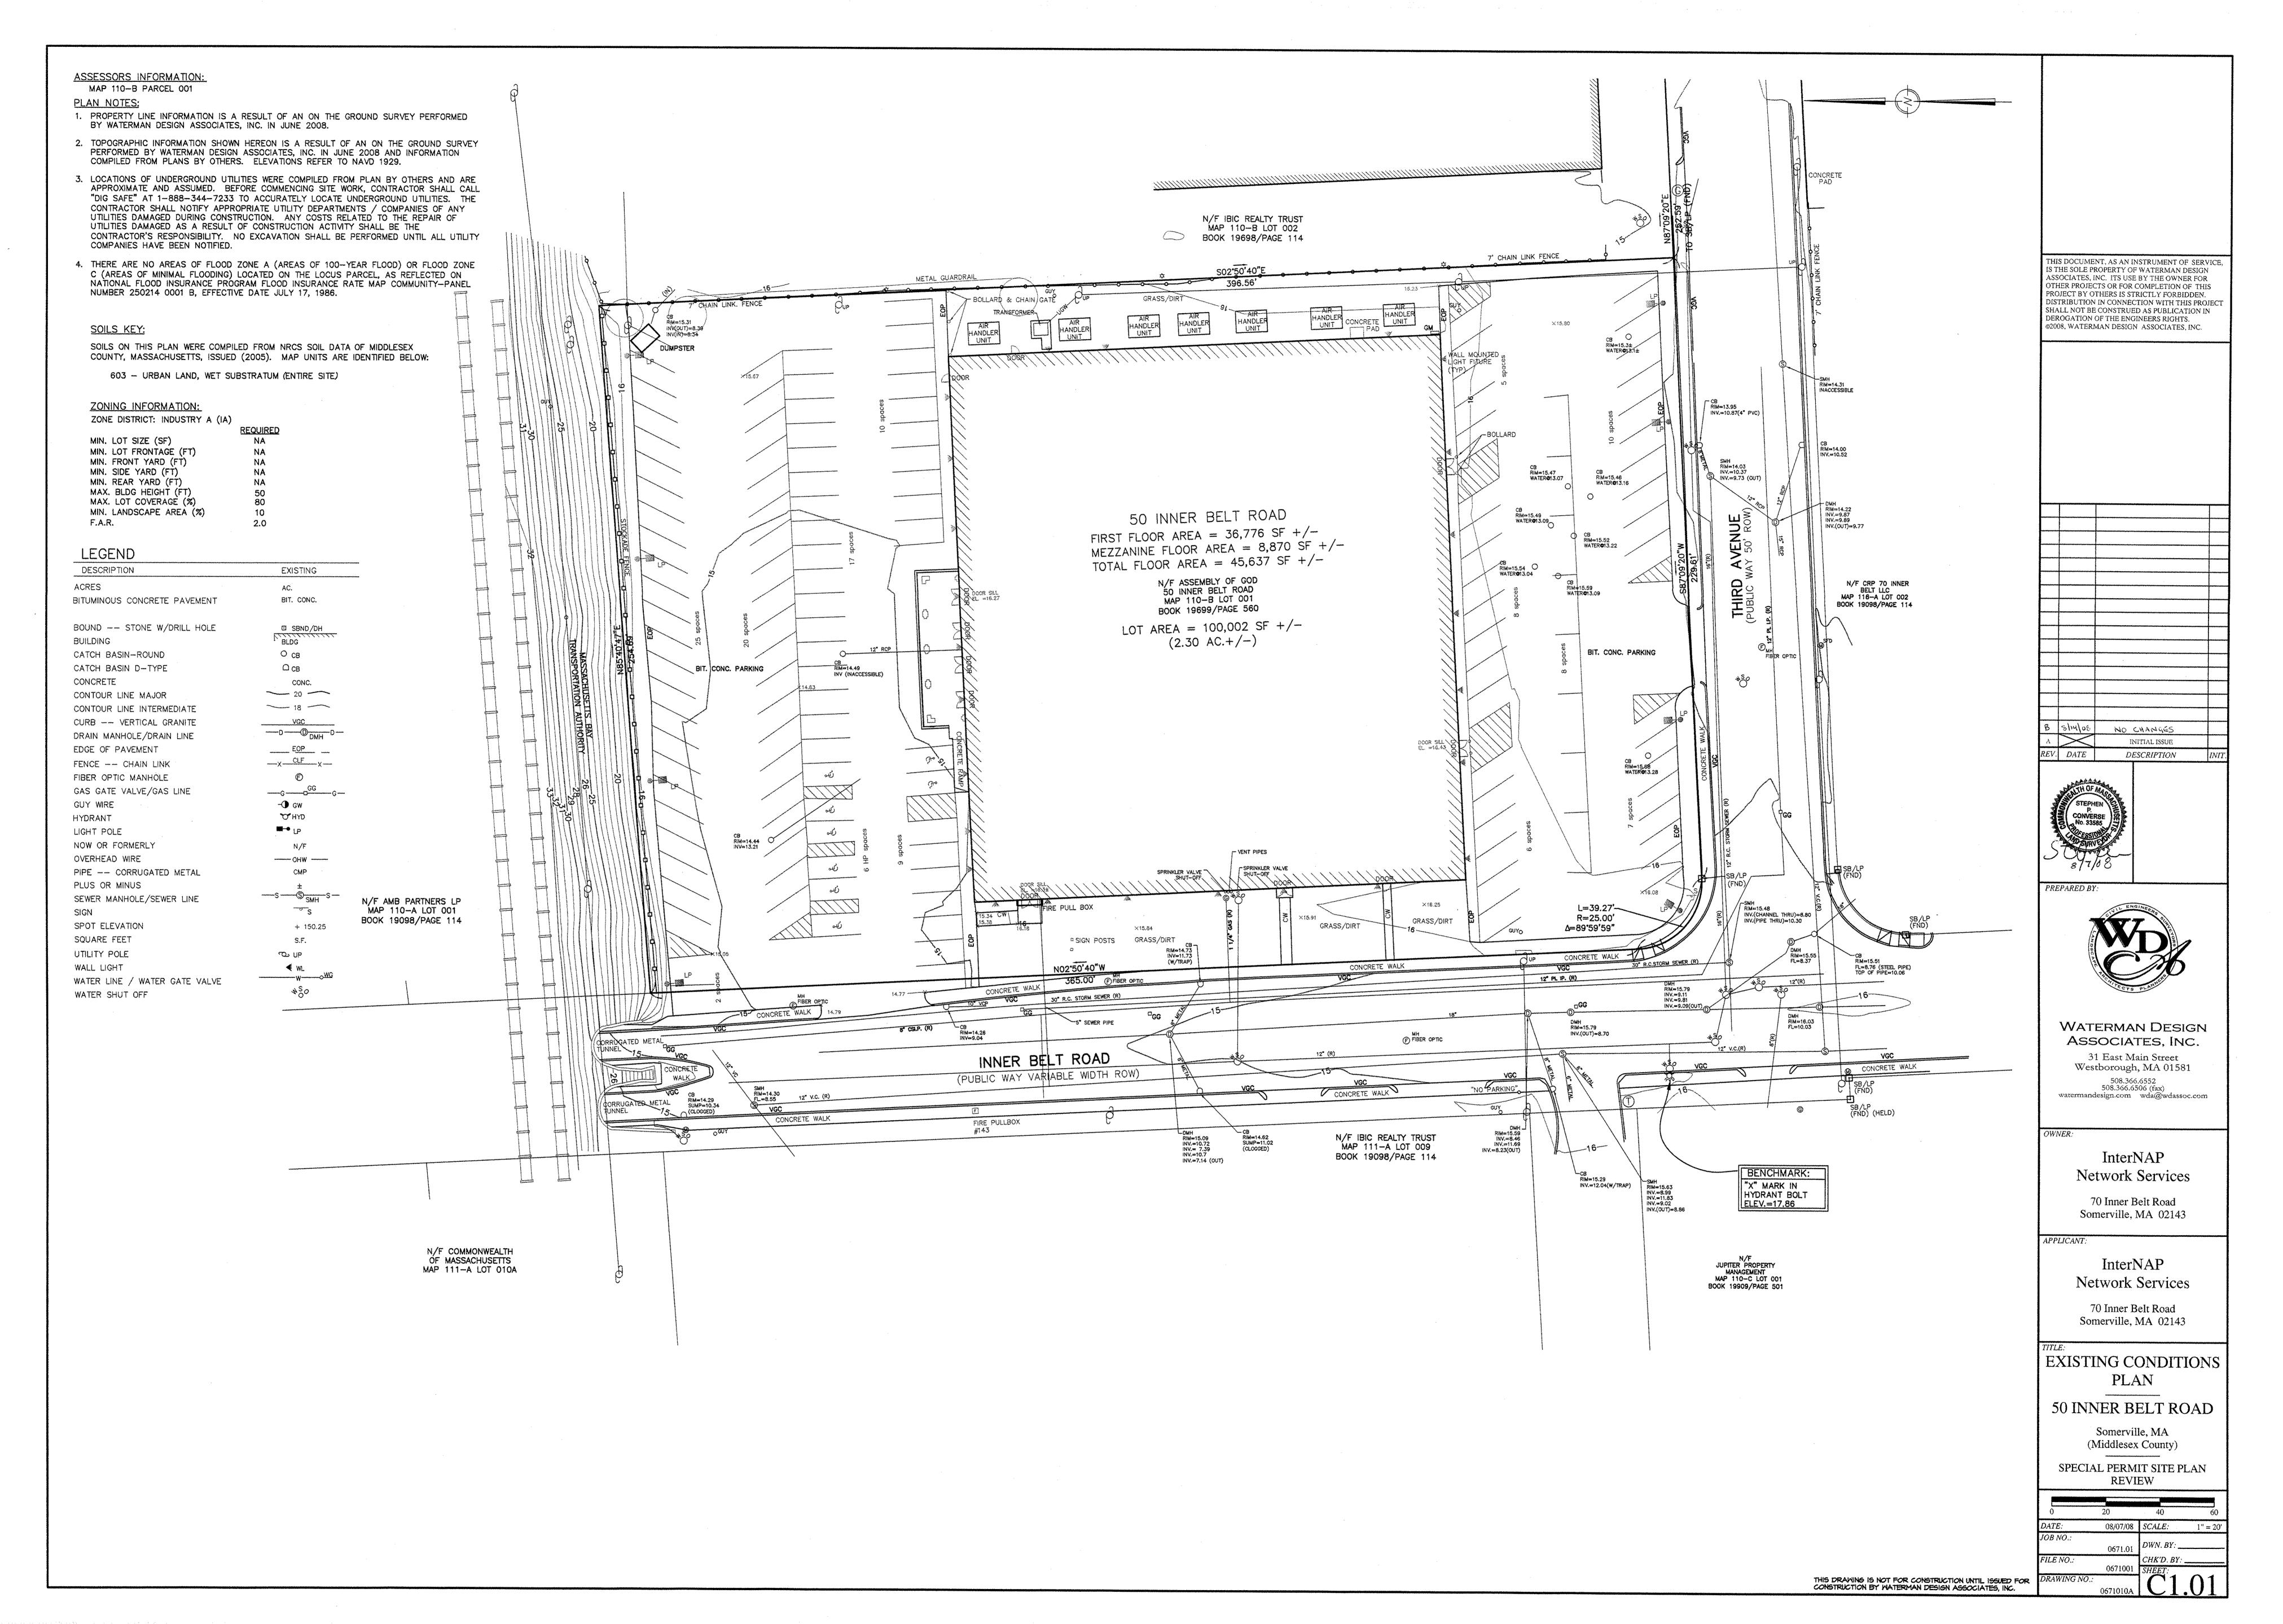


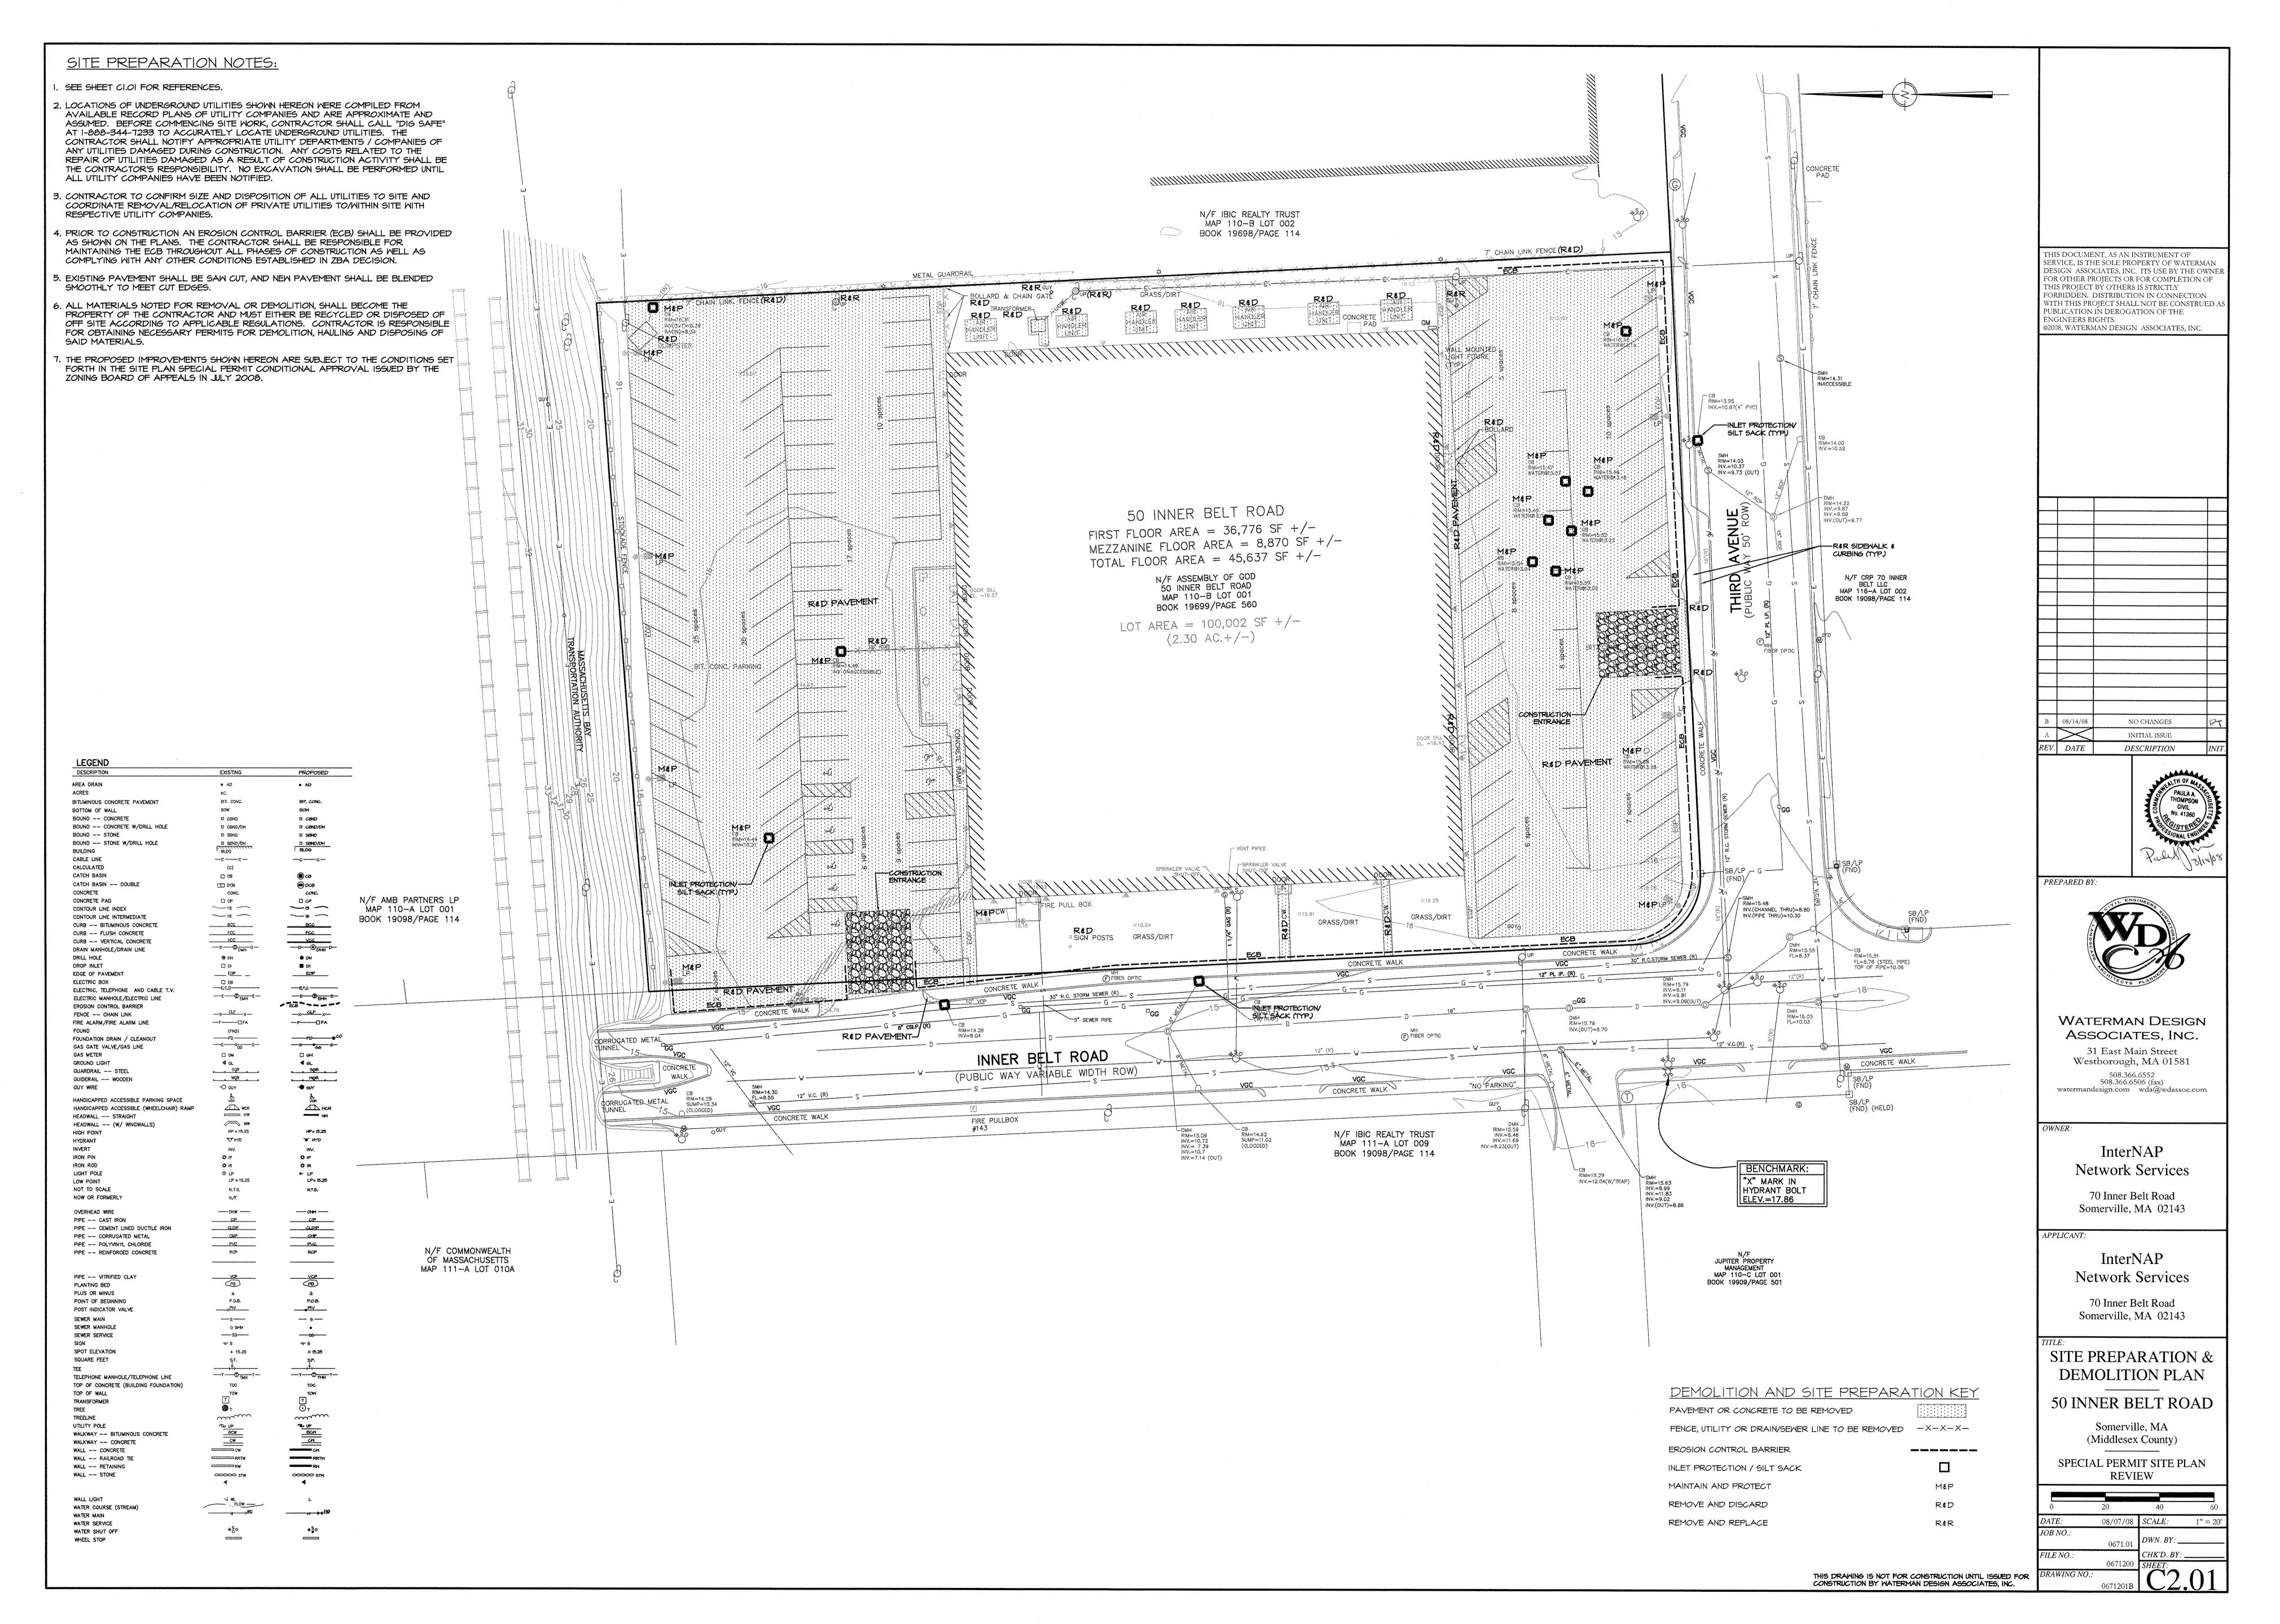

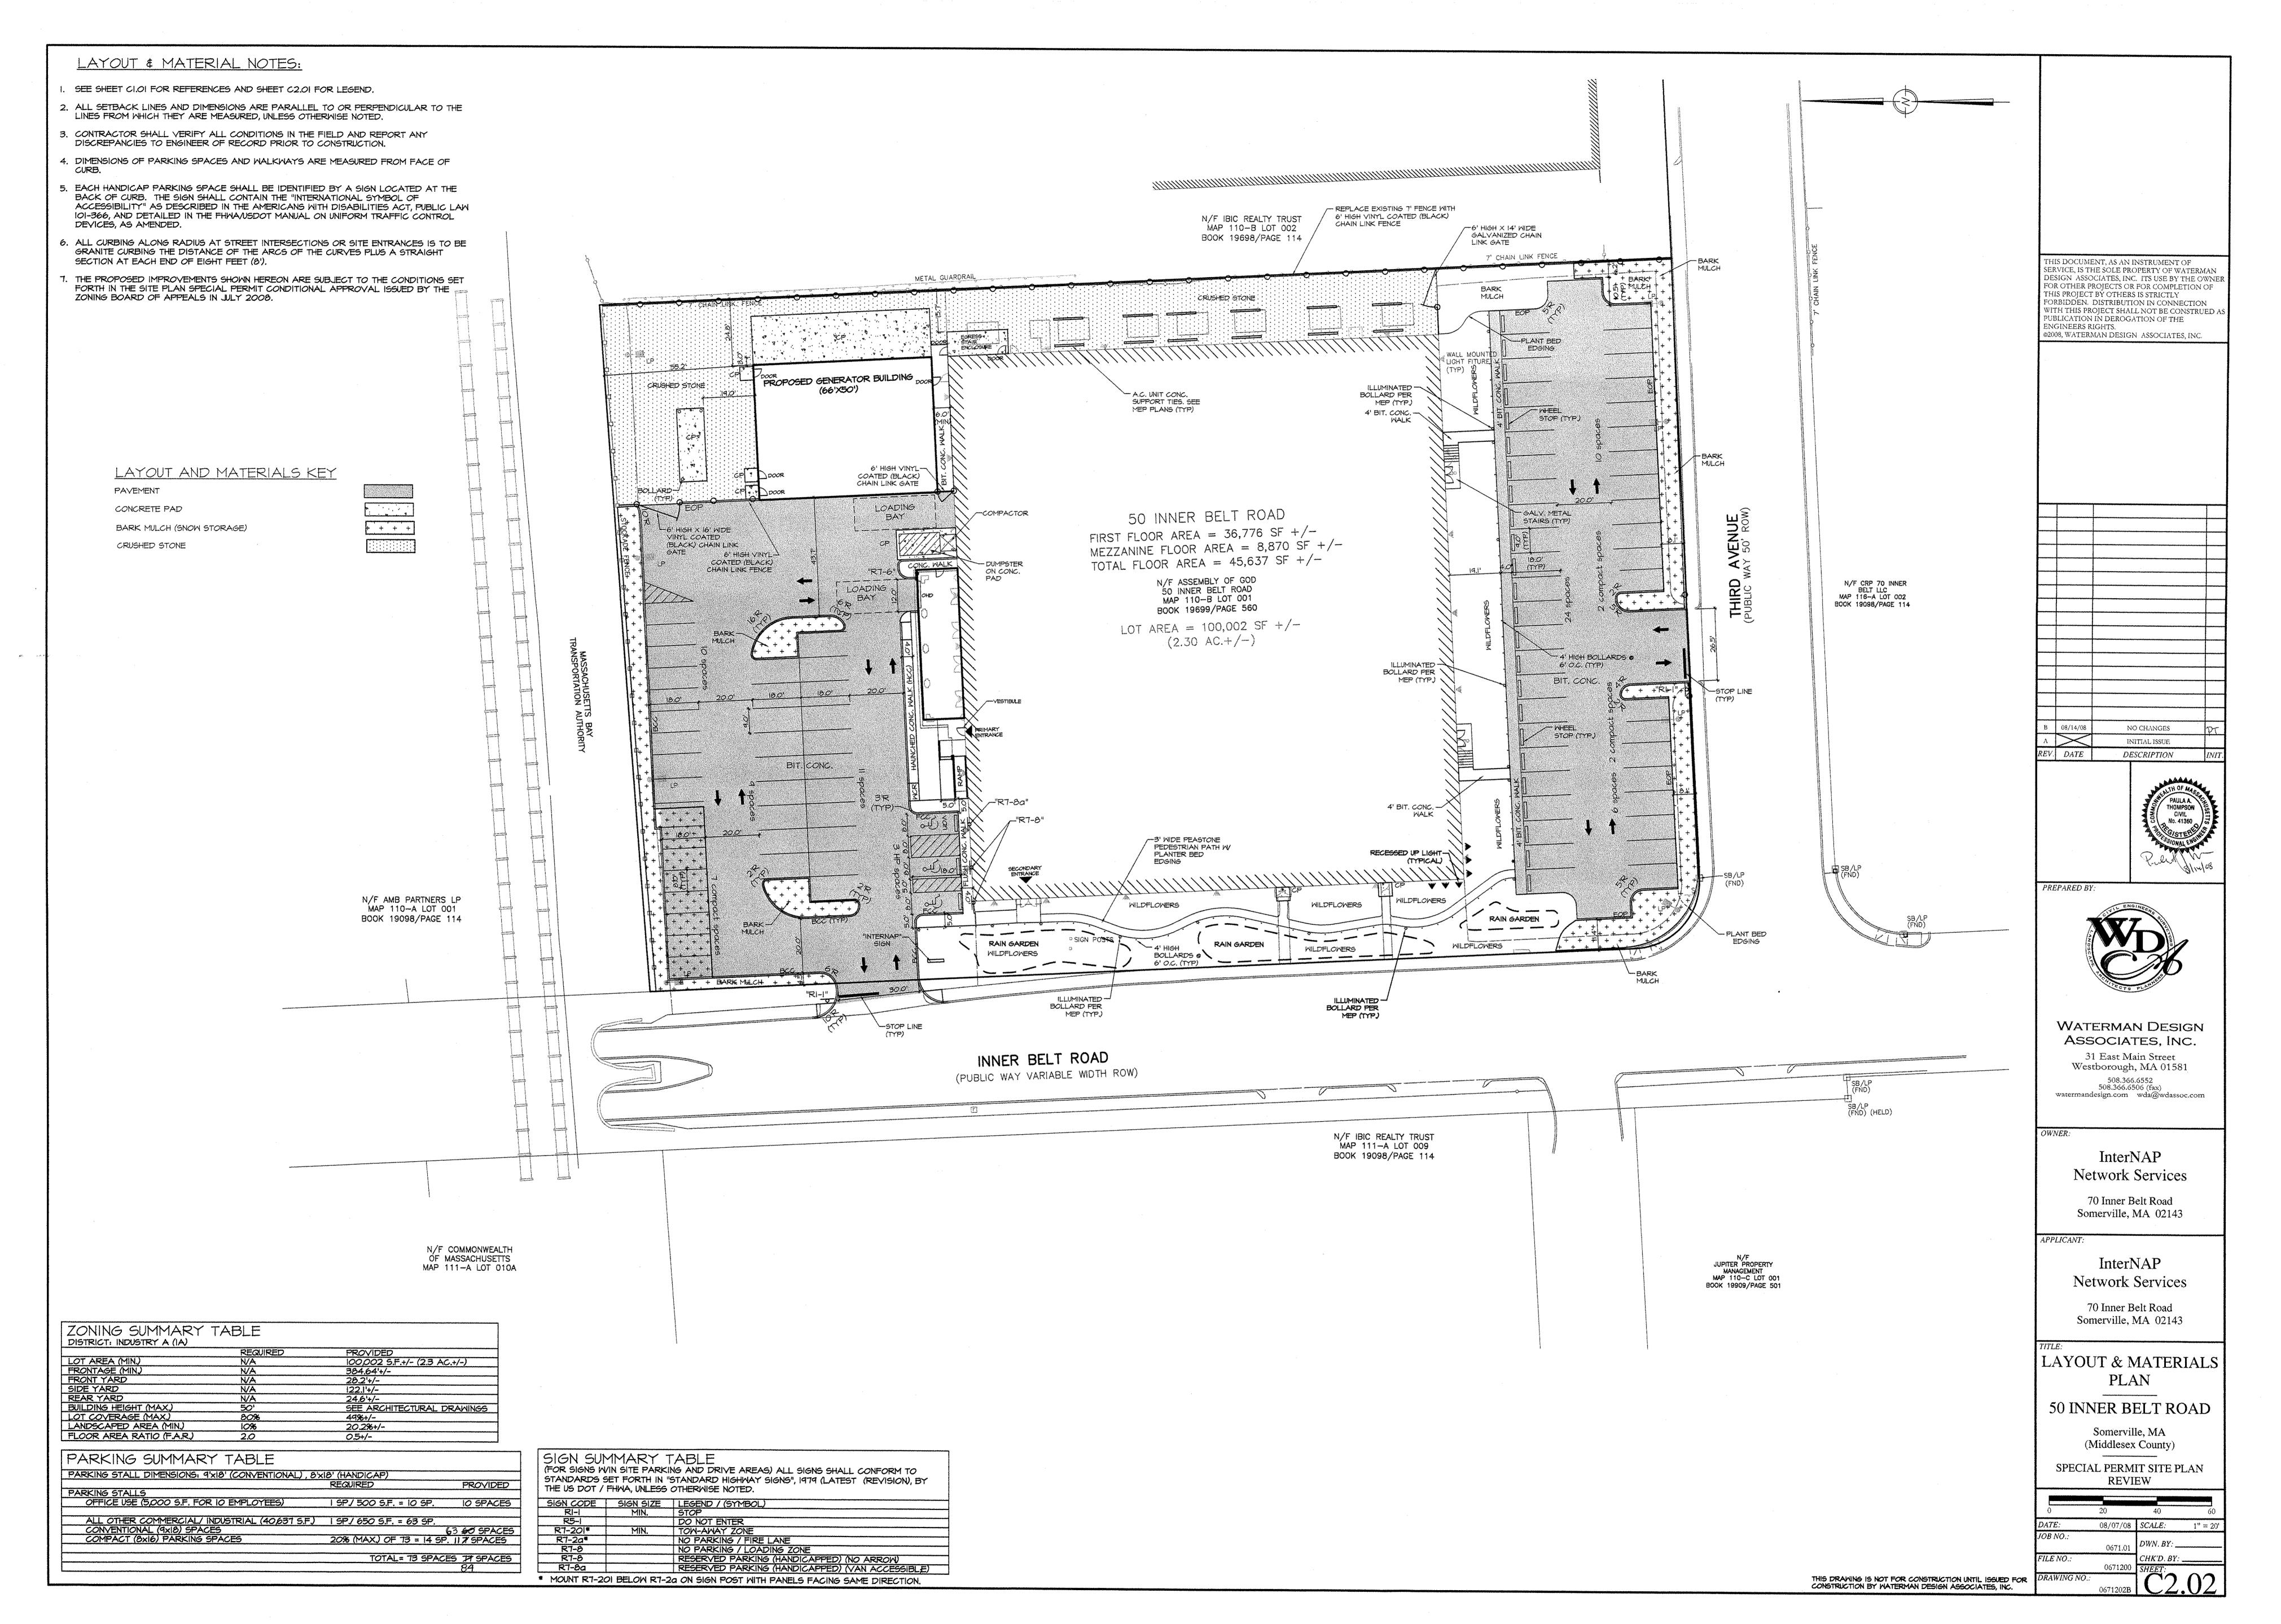

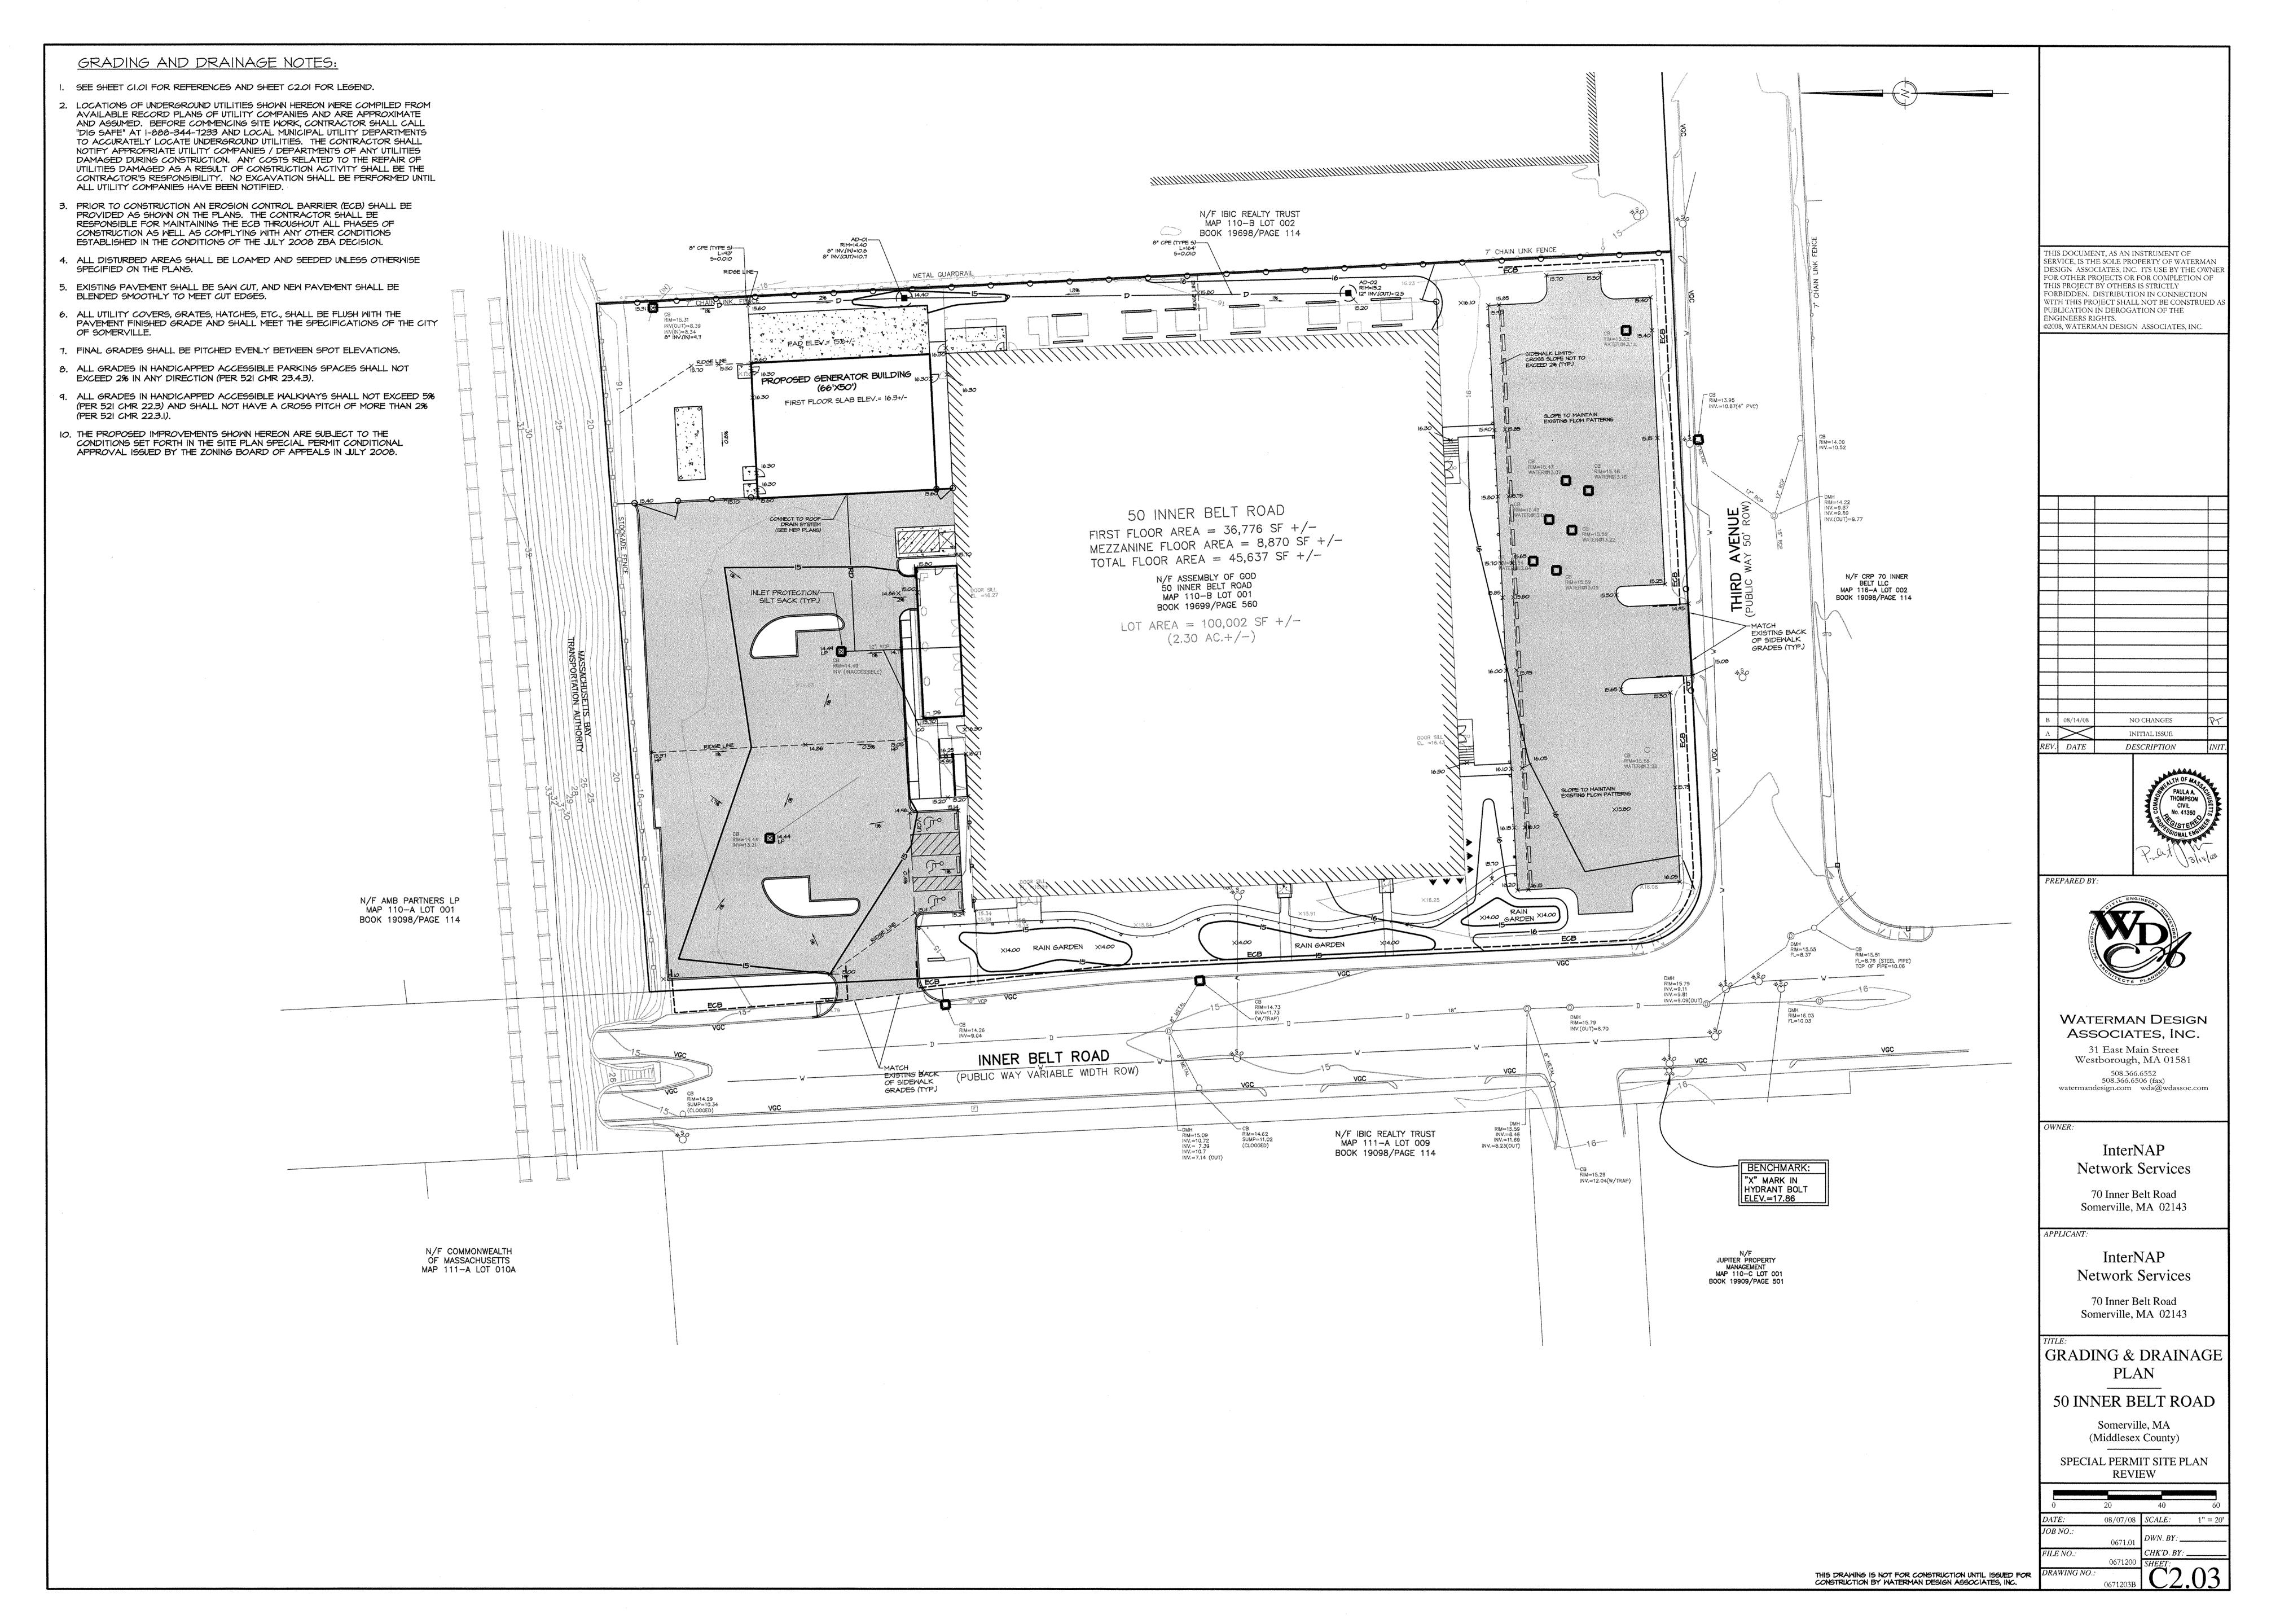


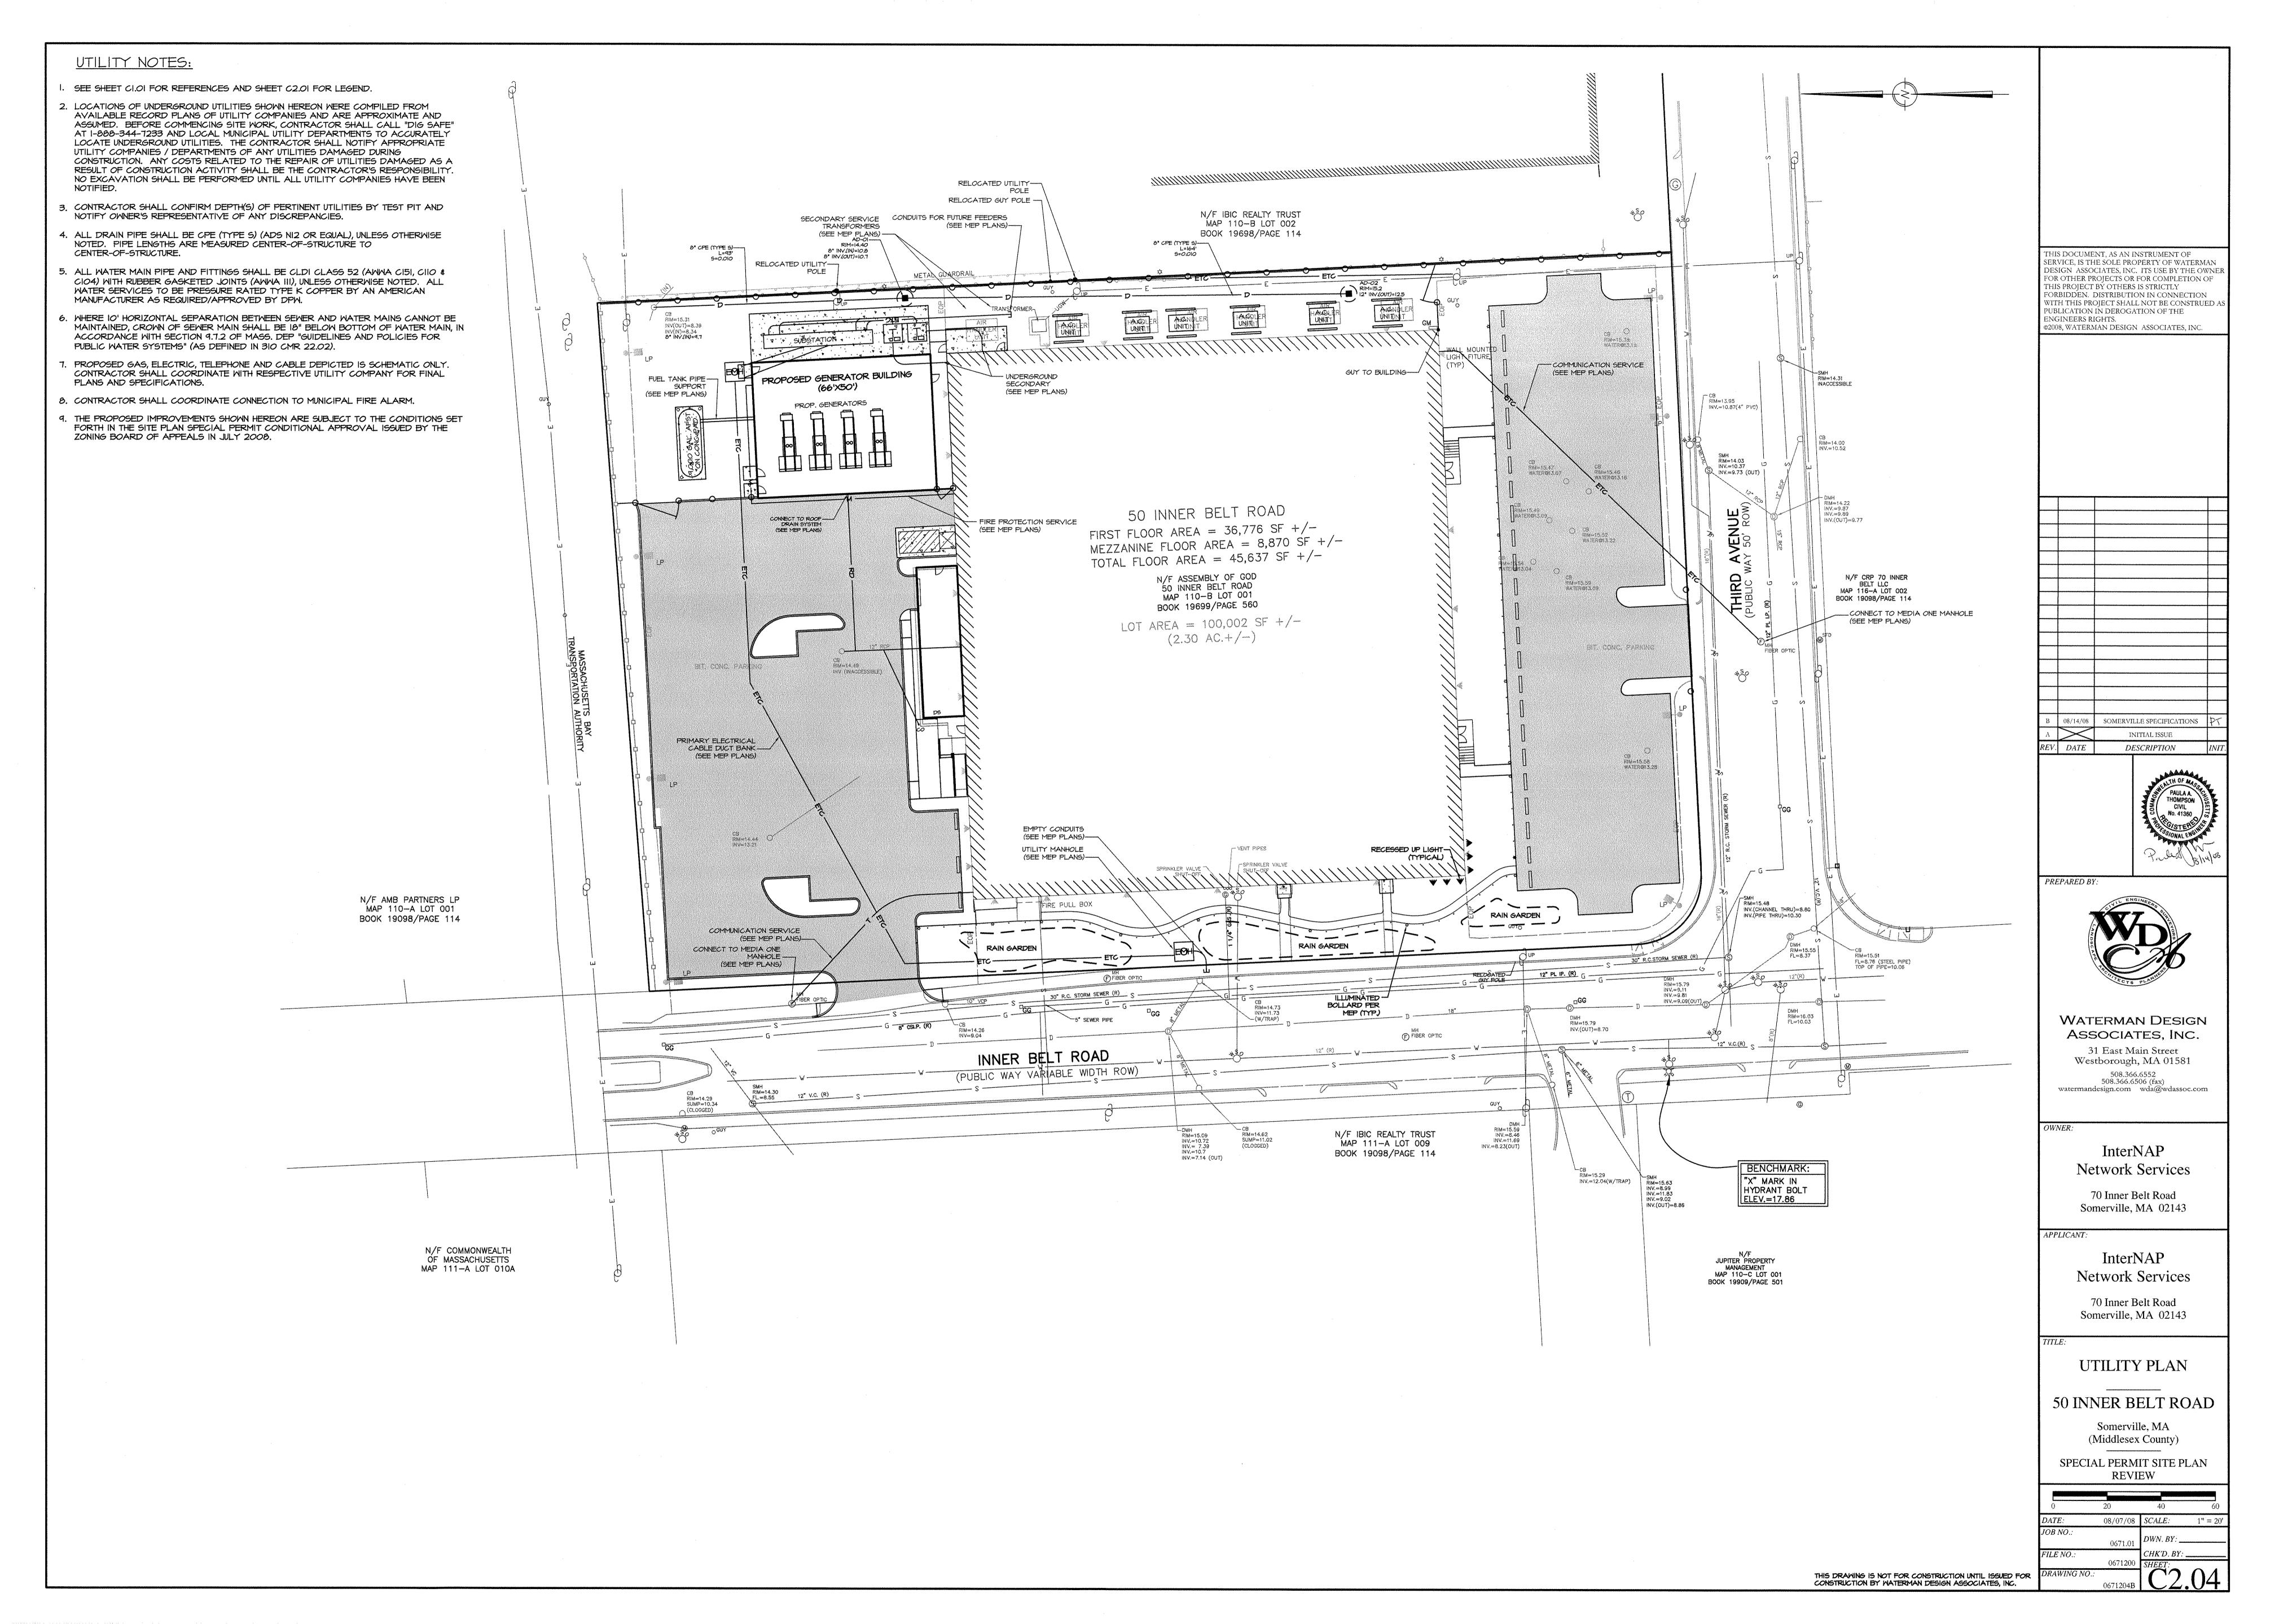

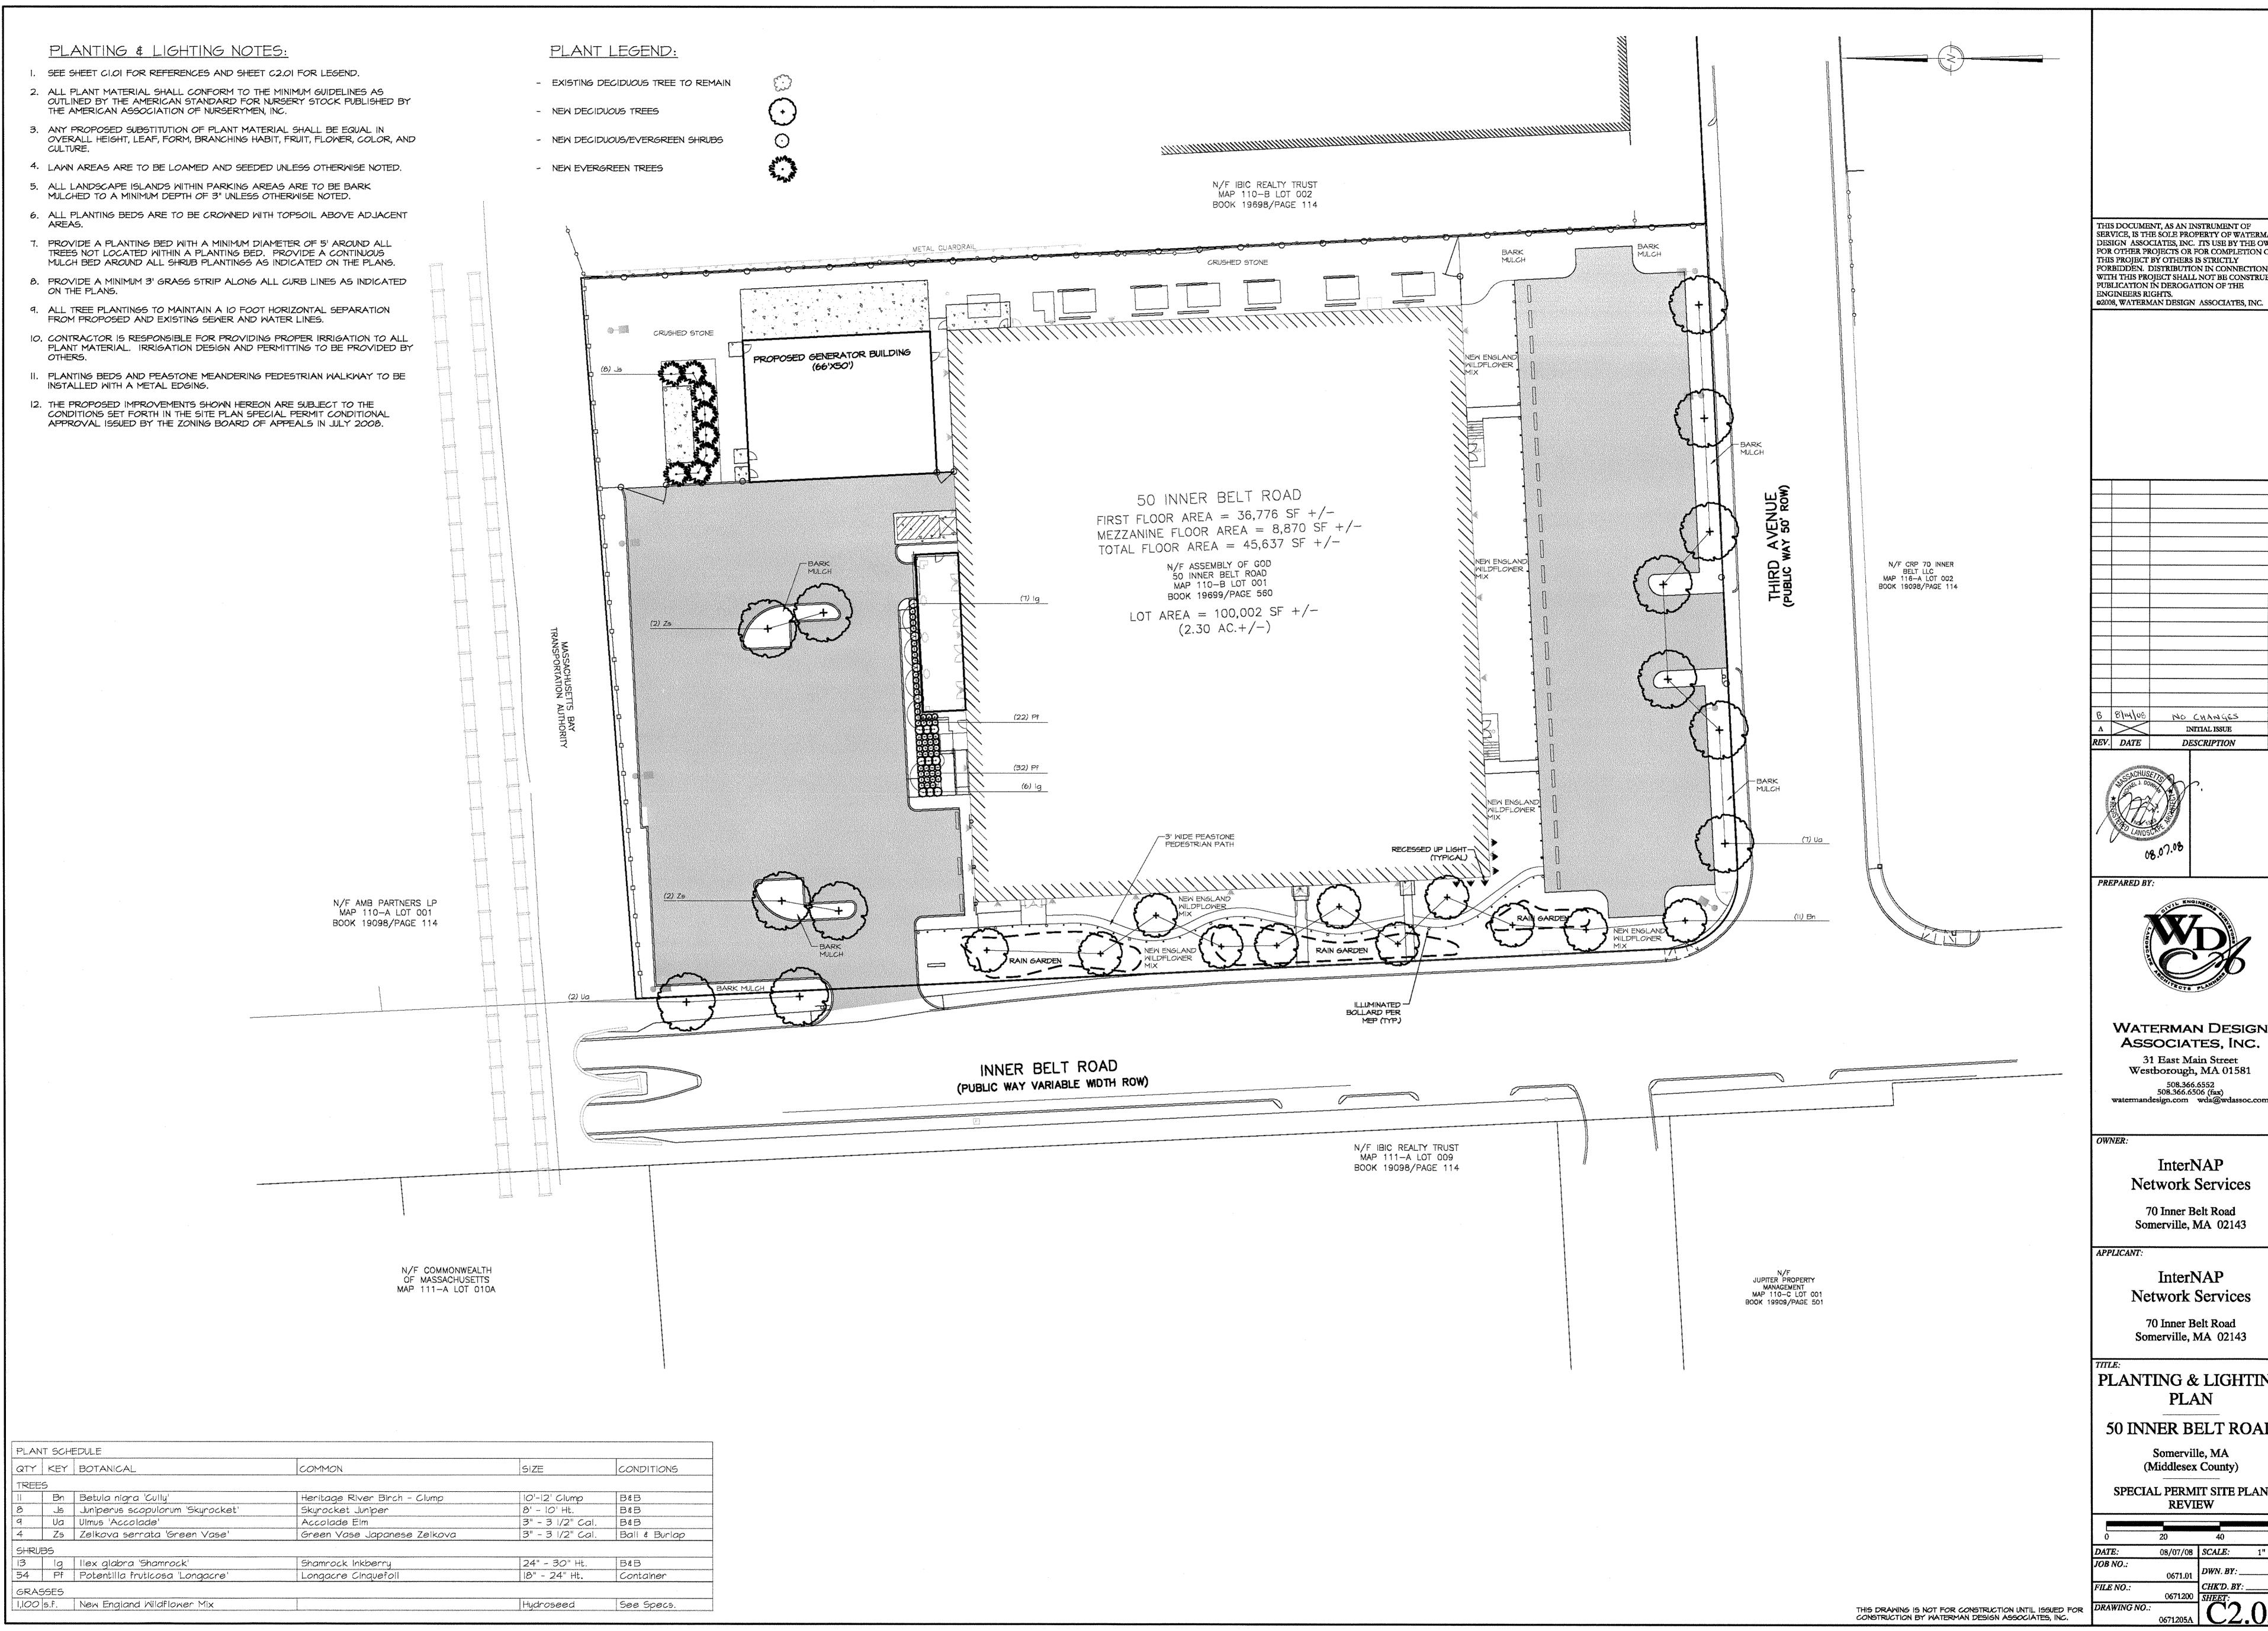

THIS DOCUMENT, AS AN INSTRUMENT OF SERVICE, IS THE SOLE PROPERTY OF WATERMAN DESIGN ASSOCIATES, INC. ITS USE BY THE OWNER FOR OTHER PROJECTS OR FOR COMPLETION OF THIS PROJECT BY OTHERS IS STRICTLY FORBIDDEN. DISTRIBUTION IN CONNECTION WITH THIS PROJECT SHALL NOT BE CONSTRUED AS PUBLICATION IN DEROGATION OF THE

NO CHANGES DESCRIPTION

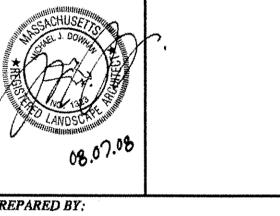



WATERMAN DESIGN Associates, Inc. 31 East Main Street Westborough, MA 01581 508.366.6552 508.366.6506 (fax) watermandesign.com wda@wdassoc.com

> InterNAP **Network Services**

InterNAP **Network Services** 


70 Inner Belt Road Somerville, MA 02143

PLANTING & LIGHTING **PLAN** 

50 INNER BELT ROAD

Somerville, MA (Middlesex County) SPECIAL PERMIT SITE PLAN

REVIEW				
0	20	40	60	
DATE:	08/07/08	SCALE:	1" = 20'	
JOB NO.:	0671.01	DWN. BY:		
FILE NO.:	0671200	CHK'D. BY: . SHEET:		
DRAWING MA				

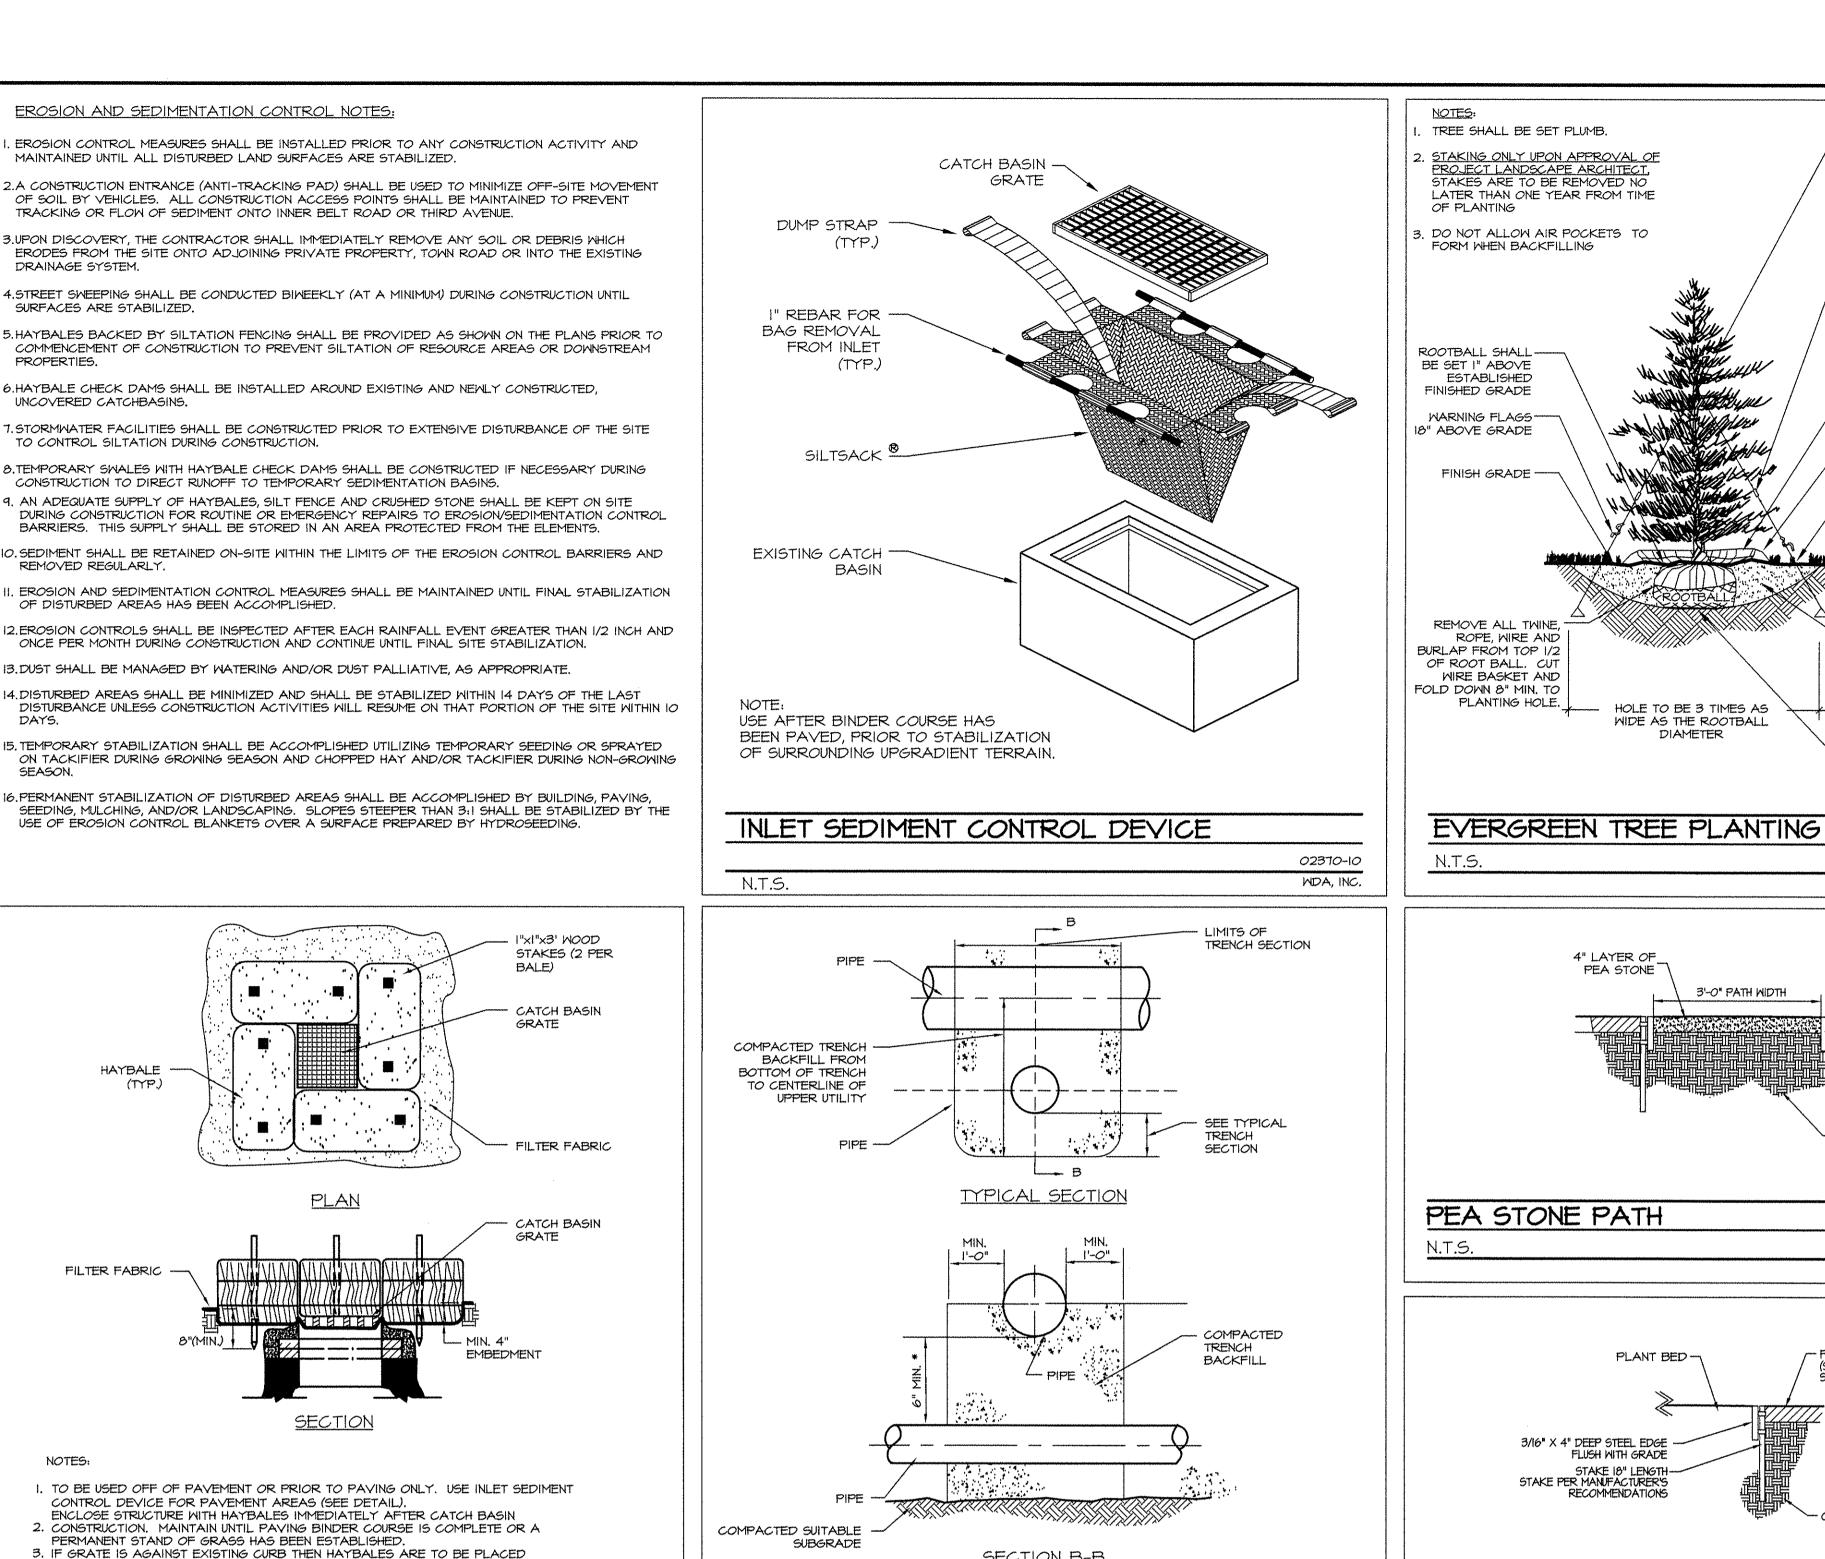

AROUND THREE SIDES OF THE GRATE ONLY.

CATCH BASIN SEDIMENT TRAP

5. HAYBALES SHALL BE INSPECTED PERIODICALLY AND AFTER ALL STORM EVENTS

AND REPAIR OR REPLACEMENT SHALL BE PERFORMED PROMPTLY AS NEEDED.

4. GRATE TO BE PLACED OVER FILTER FABRIC

I"XI"X3' WOOD STAKE -

FLOW

(MORK AREA)

GRADE

(MIM) "E

ENTRENCHED

EROSION CONTROL BARRIER (ECB)

(2 PER BALE)

SECTION B-B

PROVIDE AT ALL CONSTRUCTION ENTRANCES

50' MIN. LENGTH

- 6" MIN. DEPTH

TOP OF SENER OR SENER SHALL BE CONSTRUCTED OF AWMA C-900 PVC PIPE.

UTILITIES CROSSING

REMOVE TOPSOIL AND

GRAVEL TOPPED BY

SUITABLE SUBGRADE

CONSTRUCTION ENTRANCE

8" OF CRUSHED STONE

REPLACE WITH

N.T.S.

02370-05

NDA, INC.

STAKED HAYBALES

PROTECTED AREA


WETLAND BUFFER

02370-03

MDA, INC.

- EXISTING

EXISTING SOIL

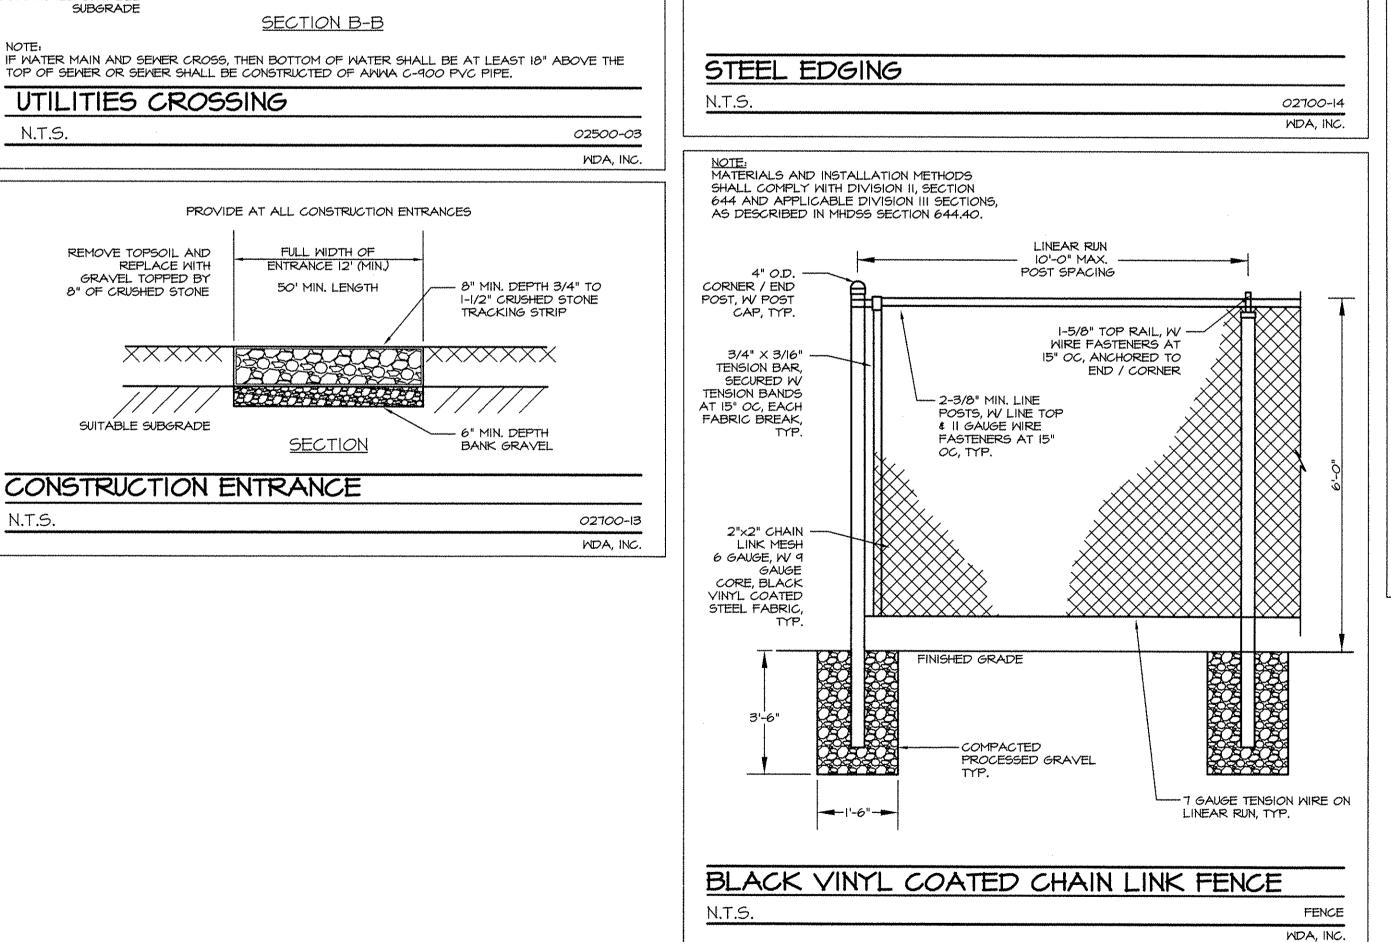

---- INSTALL THREE GUYS PER

- PROVIDE GALVANIZED

---- 3" BARK MULCH IN SAUCER

PLANTING BEDS

ROPE, WIRE AND

PLANTING HOLE.

HOLE TO BE 3 TIMES AS

WIDE AS THE ROOTBALL

3'-O" PATH WIDTH

4" LAYER OF

PEA STONE

PLANT BED -

3/16" X 4" DEEP STEEL EDGE

STAKE PER MANUFACTURER'S

FLUSH WITH GRADE

RECOMMENDATIONS

-PLANT SAUCER, 6" CONTINUOUS, NO

SAUCER WHERE TREES OCCUR IN

- SET ANGLE OF GUYS TO ENTER

GROUND AT LIMIT OF BRANCH

-PLANTING SOIL MIX: BACKFILL IN

SETTLE WITH THOROUGH WATER

LOOSE LIFTS OF 6"-8" DEPTH.

- PLACE ROOT BALL ON

(SEE PLAN FOR

(SEE PLAN FOR SURFACE TREATMENT)

COMPACTED SUBGRADE

3/16" X 4" DEEP STEEL EDGE

STAKE 18" LENGTH STAKE PER MANUFACTURER'S

FLUSH WITH GRADE

RECOMMENDATIONS

UNEXCAVATED OR TAMPED

02900-03

MDA, INC.

MDA, INC.

TURNBUCKLES; ONE

PER WIRE

TREE; EQUALLY SPACED

AROUND BALL ATTACH GUYS

DOUBLE STRAND GALVANIZED


AROUND TREE IN REINFORCED

HOSE, SECURE WIRE ENDS WITH

MALLEABLE CABLE CLAMPS

AT 2/3 HEIGHT OF TREE; USE

STEEL WIRE ENCASE WIRE

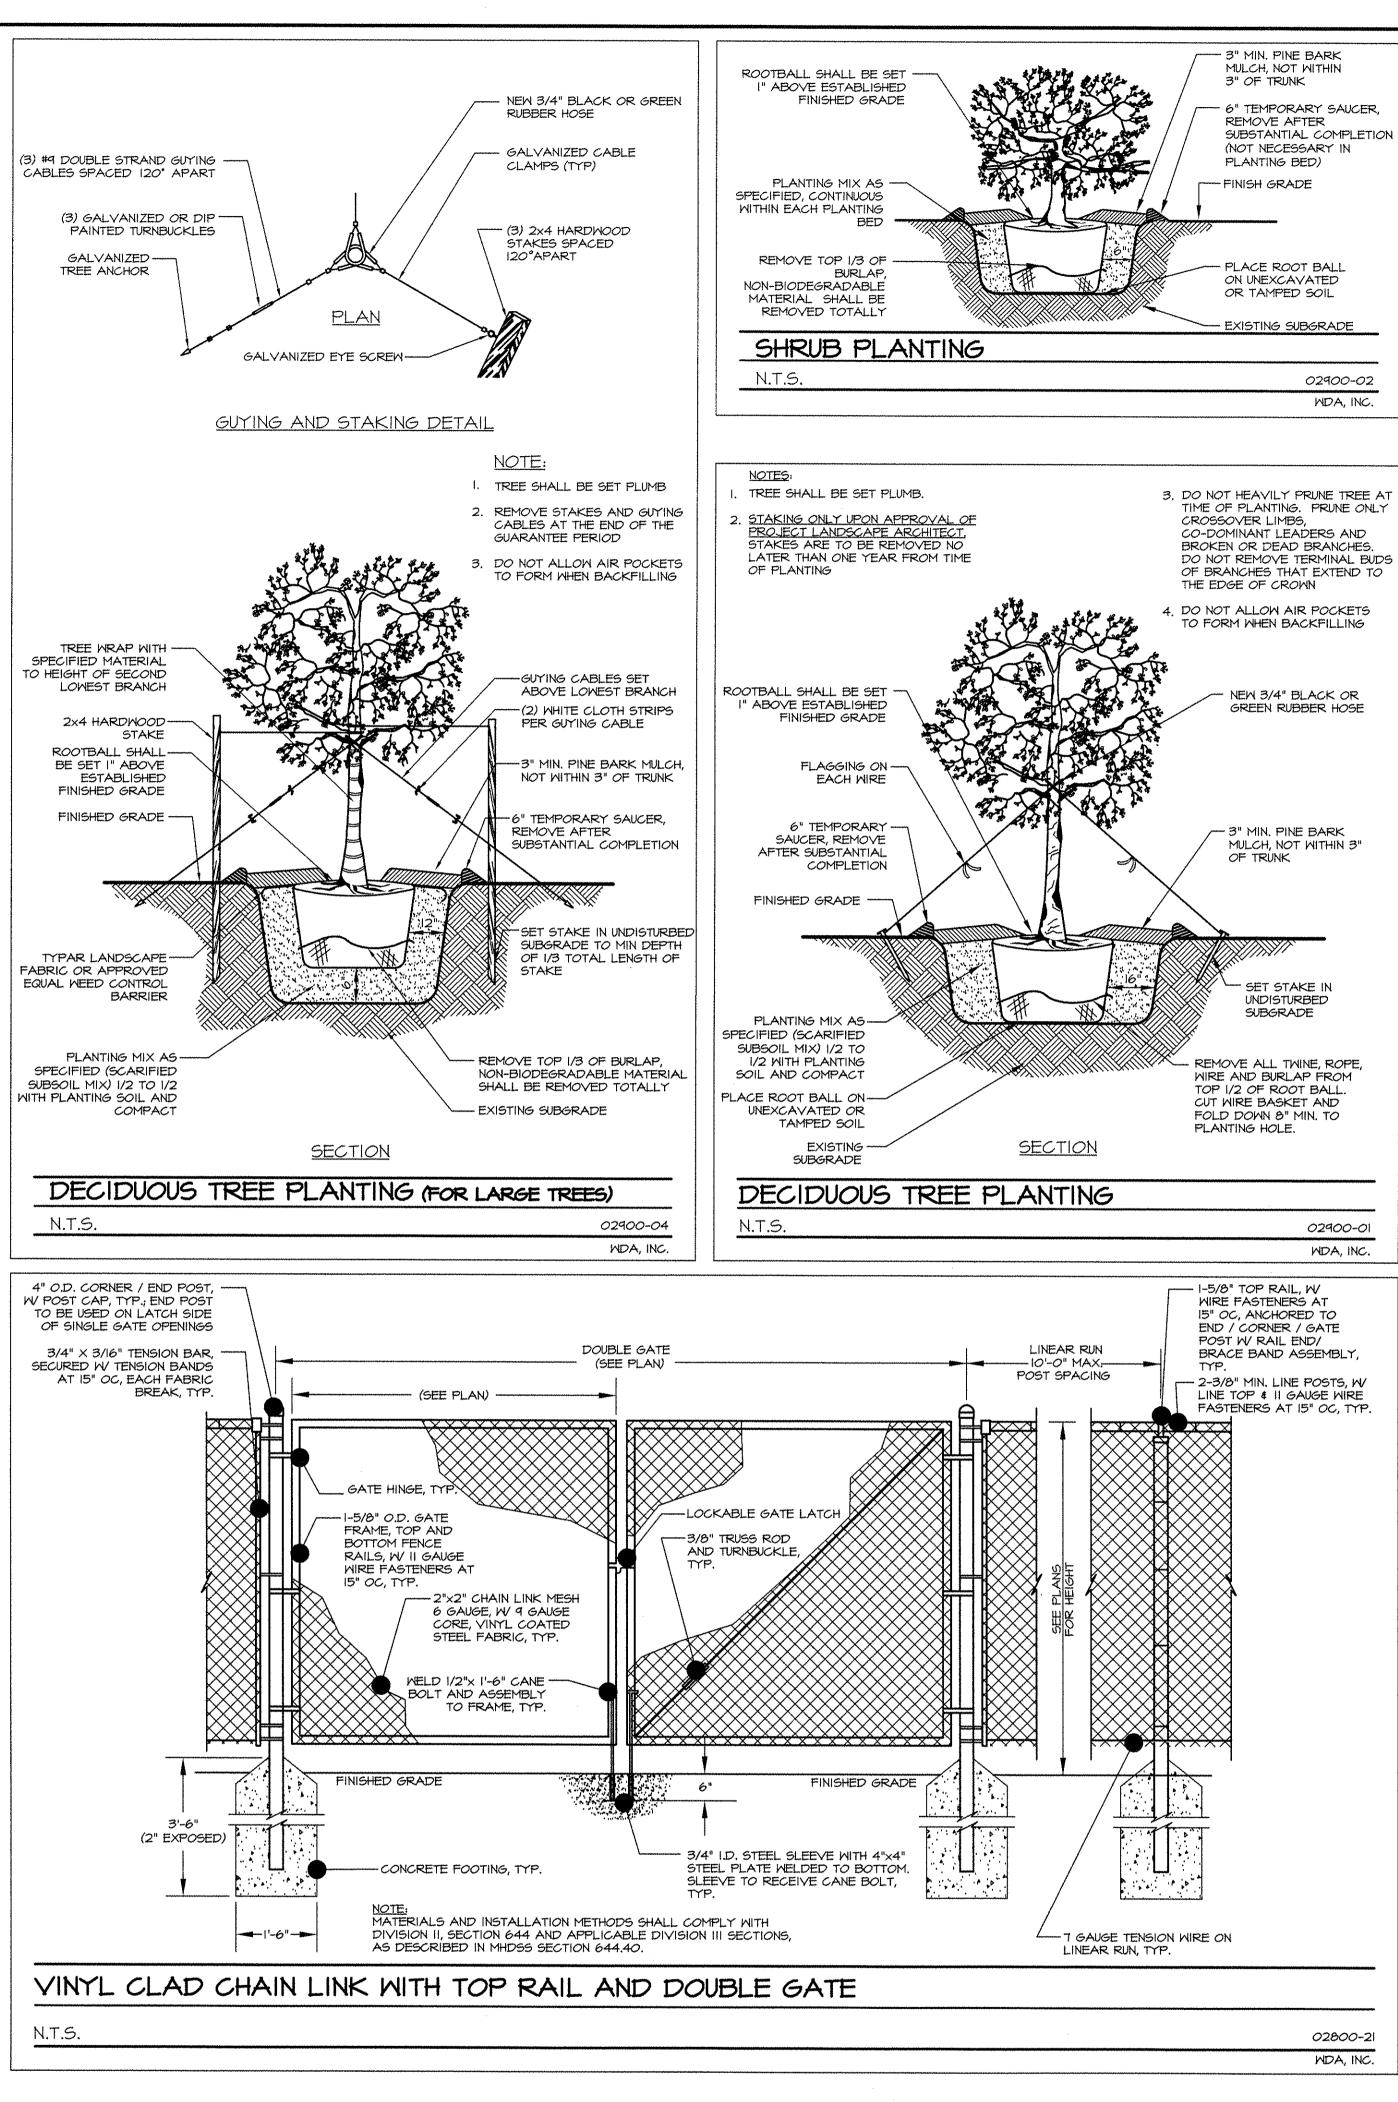

MATERIALS, MEANS AND METHODS SHALL COMPLY WITH THE CITY OF SOMERVILLE SPECIFICATIONS. MUTCD REFERS TO MANUAL ON UNIFORM TRAFFIC CONTROL DEVICES FOR STREETS AND HIGHWAYS, 1988 EDITION (AS AMENDED AND/OR STANDARD HIGHWAY SIGNS, 1979 (AS AMENDED), BOTH ISSUED BY THE USDOT/FHWA.

AASHTO REFERS TO AASHTO STANDARD SPECIFICATIONS FOR TRANSPORTATION MATERIALS AND METHODS OF SAMPLING AND TESTING, PART I - SPECIFICATIONS, TWENTIETH EDITION (AS AMENDED). MHDSS REFERS TO MASS, HIGHWAY DEPT. STANDARD SPECIFICATIONS FOR HIGHWAYS AND BRIDGES, 1988 (AS AMENDED).

DPW REFERS TO LOCAL DEPARTMENT OF PUBLIC WORKS. THIS DRAWING IS NOT FOR CONSTRUCTION UNTIL ISSUED FOR CONSTRUCTION BY WATERMAN DESIGN ASSOCIATES, INC.

DATE:	08/07/08	SCALE: AS NOTE
JOB NO.:		DWN. BY:
	0671.01	
FILE NO.:	0671500	CHK'D. BY;
SSAURNA NA	0671500	SHEET:
DRAWING NO.:		16 73 111
,	0671501B	

THIS DOCUMENT, AS AN INSTRUMENT OF SERVICE,

THE SOLE PROPERTY OF WATERMAN DESIGN

ASSOCIATES, INC. ITS USE BY THE OWNER FOR

OTHER PROJECTS OR FOR COMPLETION OF THIS

DISTRIBUTION IN CONNECTION WITH THIS PROJECT

NO CHANGES

INITIAL ISSUE

DESCRIPTION

WATERMAN DESIGN

ASSOCIATES, INC.

31 East Main Street

Westborough, MA 01581

508.366.6552

508.366.6506 (fax)

watermandesign.com wda@wdassoc.com

InterNAP

Network Services

70 Inner Belt Road

Somerville, MA 02143

InterNAP

**Network Services** 

70 Inner Belt Road

Somerville, MA 02143

**DETAILS** 

50 INNER BELT ROAD

Somerville, MA (Middlesex County)

SPECIAL PERMIT SITE PLAN

REVIEW

B 08/14/08

REV. DATE

PREPARED BY:

OWNER:


APPLICANT:


HALL NOT BE CONSTRUED AS PUBLICATION IN

PROJECT BY OTHERS IS STRICTLY FORBIDDEN.

DEROGATION OF THE ENGINEERS RIGHTS.

©2008, WATERMAN DESIGN ASSOCIATES, INC.

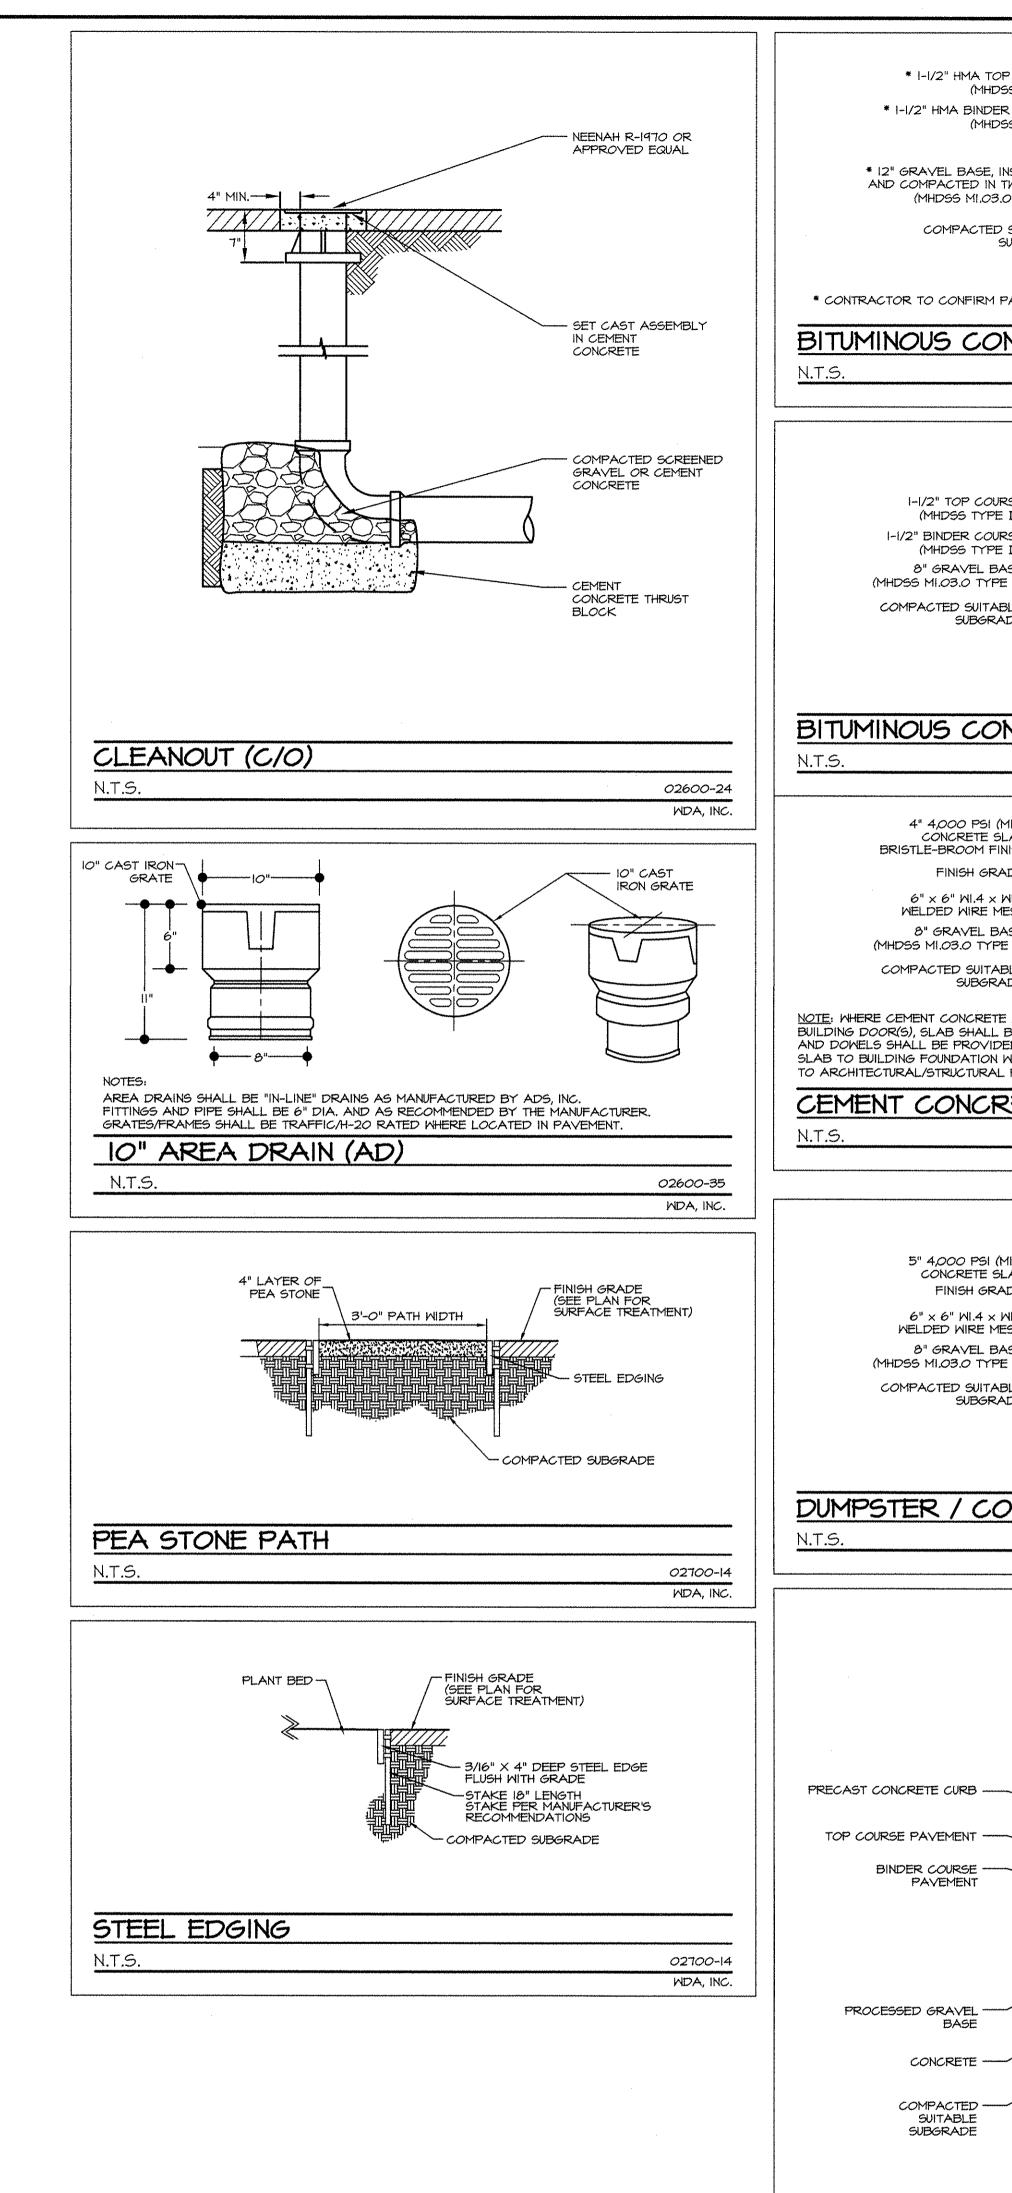

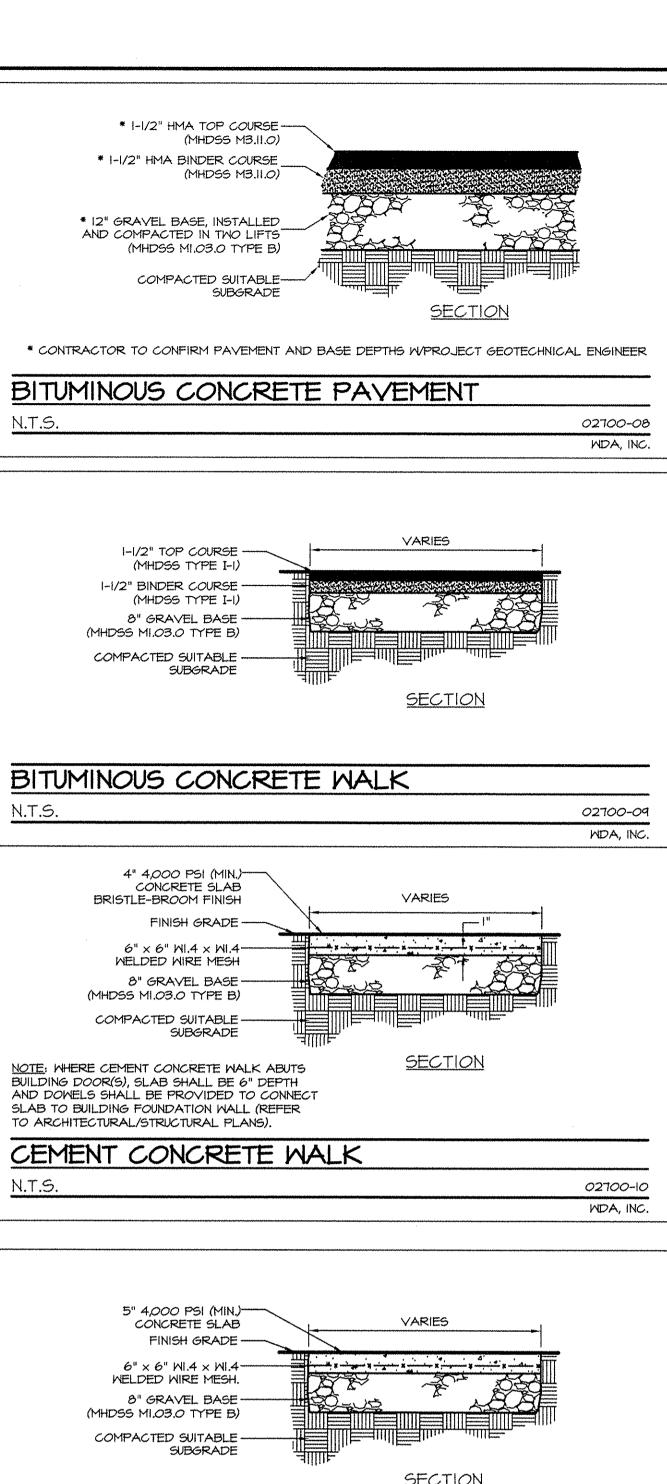

3/4" RADIUS ----

BINDER COURSE -


PROCESSED GRAVEL -


CONCRETE -


COMPACTED -SUITABLE SUBGRADE


PRECAST CONCRETE CURB (CC)

REVEAL

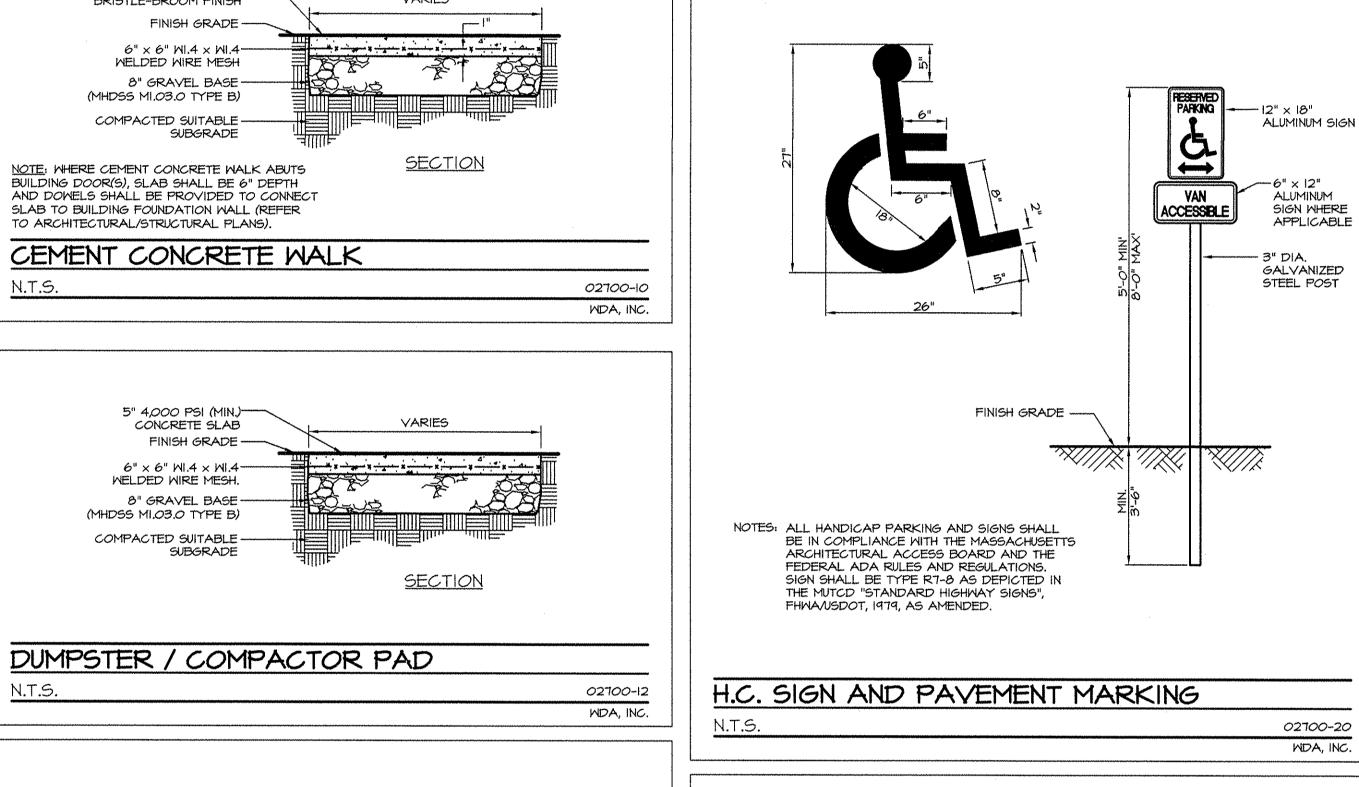

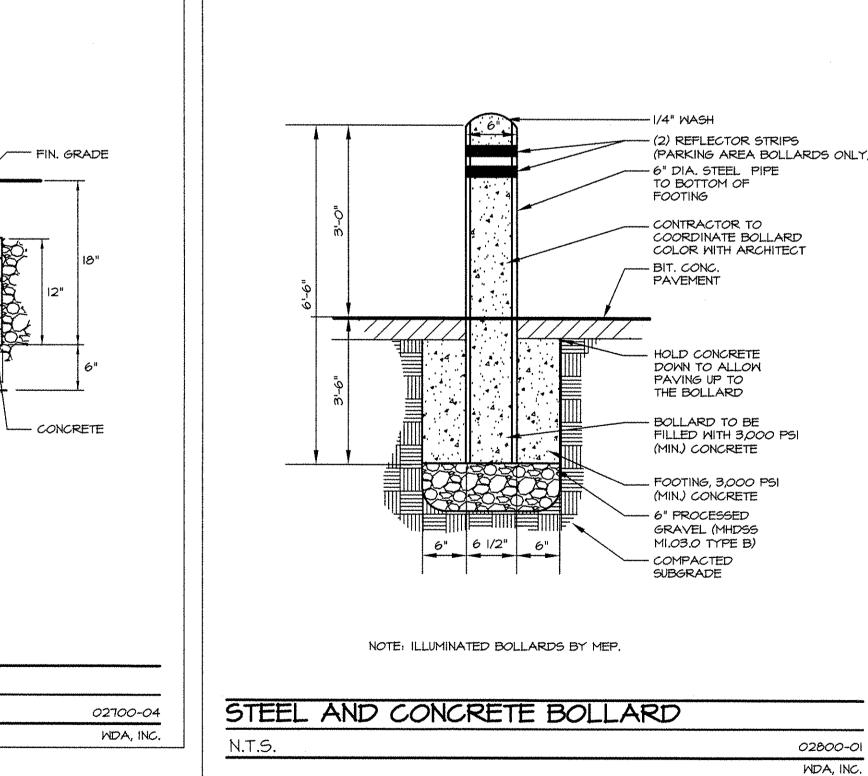

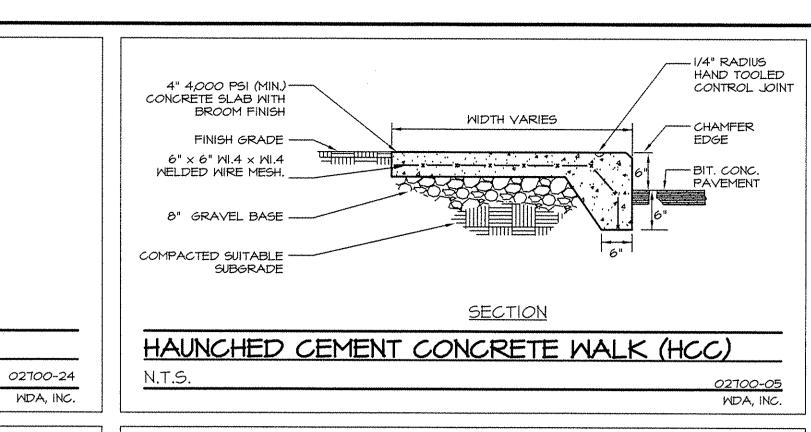

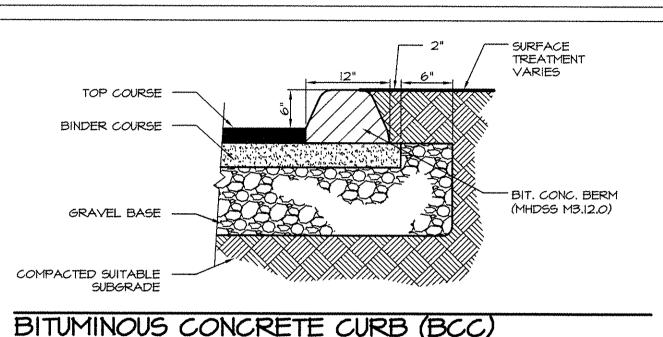

BITUMINOUS CONCRETE CURB (BCC) N.T.S. 02700-21 MDA, INC.


-3/4" DIA. HOLE FOR #5


SIDE VIEW

ISO VIEW

PRECAST CONCRETE CURB STOP

REBAR ANCHOR (TYP.)

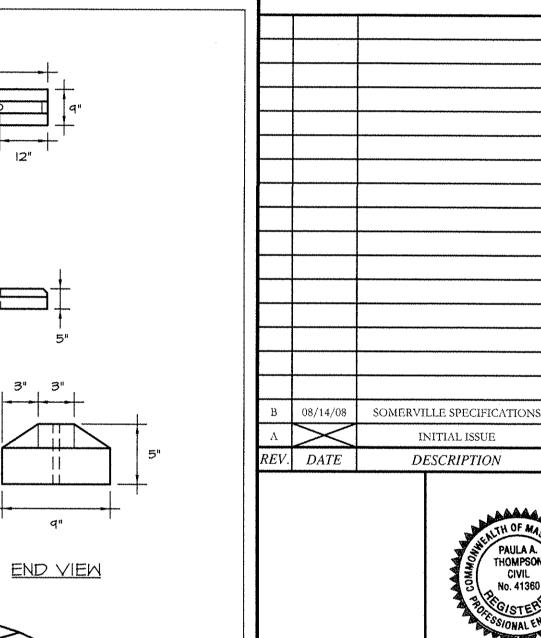

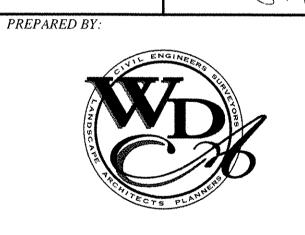

THIS DOCUMENT, AS AN INSTRUMENT OF SERVICE.

S THE SOLE PROPERTY OF WATERMAN DESIGN ASSOCIATES, INC. ITS USE BY THE OWNER FOR OTHER PROJECTS OR FOR COMPLETION OF THIS

PROJECT BY OTHERS IS STRICTLY FORBIDDEN.

DEROGATION OF THE ENGINEERS RIGHTS.

©2008, WATERMAN DESIGN ASSOCIATES, INC.

DISTRIBUTION IN CONNECTION WITH THIS PROJECT

SHALL NOT BE CONSTRUED AS PUBLICATION IN

WATERMAN DESIGN ASSOCIATES, INC. 31 East Main Street Westborough, MA 01581 508.366.6552 508.366.6506 (fax)

OWNER:

02700-25

MDA, INC.

- EDGE TOOL FINISH

BACKING ROD.

SEALANT TO MIN. 1/2" DEPTH, TYPE POLYURETHANE

12" EXPANSION SLEEVE,

#4 SMOOTH (GRADE 60)

REBAR DOWEL 2'-O" O.C.

PREMOLDED EXPANSION

(ASTM D 1752). REMOVE

CAP AFTER PLACEMENT.

TOOL CONTROL JOINT TO DIMENSIONS SHOWN

WITH I 1/2" EDGER

JOINT WITH STRIP OFF CAP TO FORM SEALANT JOINT

I. EXPANSION JOINTS 20' O.C. UNLESS OTHERWISE NOTED

2. CONTROL JOINTS 5' O.C. UNLESS OTHERWISE NOTED

3. WHERE EXISTING AND NEW

CONCRETE MEET, SAWCUT EXISTING WALK AND INSTALL

RECEIVE STEEL DOWELS AT

EXPANSION JOINT.

MUTCO REFERS TO MANUAL ON UNIFORM TRAFFIC CONTROL DEVICES FOR STREETS AND HIGHWAYS, 1988 EDITION (AS AMENDED AND/OR STANDARD HIGHWAY SIGNS, 1979 (AS AMENDED), BOTH ISSUED BY THE USDOT/FHMA.

AASHTO REFERS TO AASHTO STANDARD SPECIFICATIONS FOR TRANSPORTATION MATERIALS AND METHODS OF SAMPLING AND TESTING, PART I - SPECIFICATIONS, TWENTIETH EDITION (AS AMENDED).

MHDSS REFERS TO MASS, HIGHWAY DEPT. STANDARD SPECIFICATIONS FOR HIGHWAYS AND BRIDGES,

THIS DRAWING IS NOT FOR CONSTRUCTION UNTIL ISSUED FOR CONSTRUCTION BY WATERMAN DESIGN ASSOCIATES, INC.

EXPANSION JOINT AND DOWELS AS SHOWN. DRILL EXISTING CONCRETE WALK EDGE TO

02700-17

MDA, INC.

WITH WAXED TUBE TO

PREVENT BONDING

(ASTM D 3406). PROVIDE

TYPICAL MEDIUM BROOM FINISH

InterNAP **Network Services** 

watermandesign.com wda@wdassoc.com

70 Inner Belt Road Somerville, MA 02143

APPLICANT:

InterNAP **Network Services** 

70 Inner Belt Road Somerville, MA 02143


**DETAILS** 

50 INNER BELT ROAD

Somerville, MA (Middlesex County)

SPECIAL PERMIT SITE PLAN **REVIEW** 

08/07/08 | SCALE: AS NOTED 0671.01 CHK'D. BY: 0671500

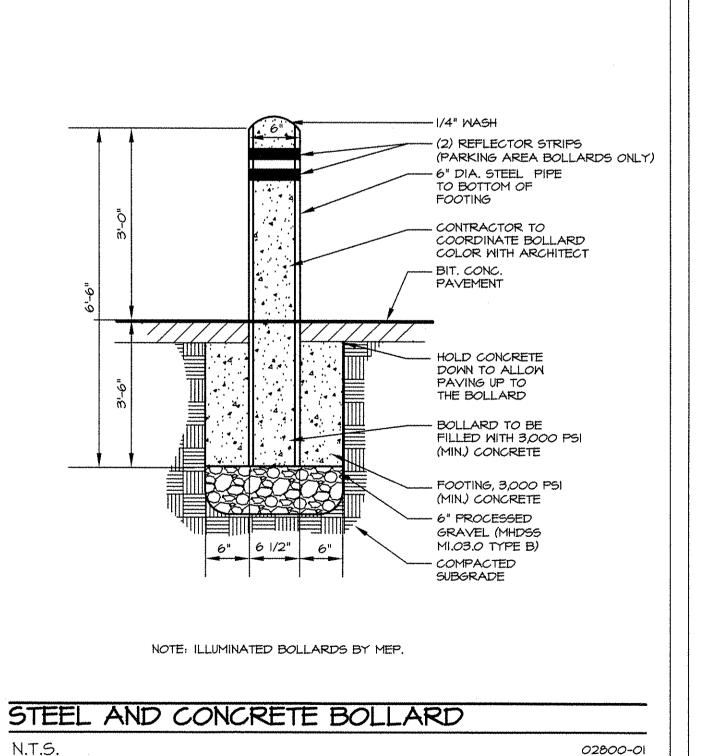

FLUSH CURB -

CONCRETE "LEVEL LANDING" WITH 1.5% CROSS PITCH FOR

-SHALL BE CONSTRUCTED OF THE SAME MATERIAL AS SIDEWALK. -ALL SLOPES AND DIMENSIONS SHALL COMPLY WITH 521 CMR.

-TRANSITION CURB LENGTH (HIGH SIDE) PER MASS DPW M/E 107.9.0

WHEELCHAIR RAMP (WCR-C) - TYPE C

ROADWAY

FACE OF CURB

ROADWAY

-TRANSITION CURB LENGTH SHALL BE 6'-6" (MIN).

FLUSH CURB -


WHEEL CHAIR RAMP (WCR)

I. ALL SLOPES AND DIMENSIONS SHALL COMPLY WITH 521 CMR.

2. L=6' (MIN) FOR 6" WALK L=3' (MIN) FOR 3" BERM

N.T.S.

DRAINAGE

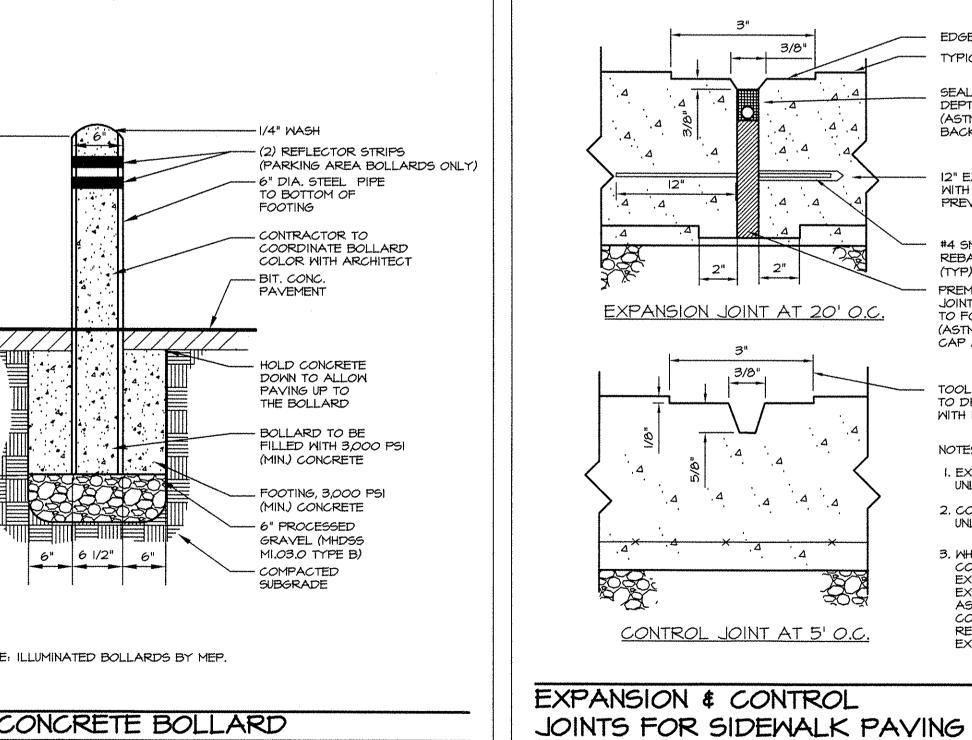

MDA, INC.

02700-24

MDA, INC.

NOTES:

N.T.S.

1988 (AS AMENDED).

DPW REFERS TO LOCAL DEPARTMENT OF PUBLIC WORKS.

I. PRECAST CONCRETE WHEEL STOPS SHALL GENERALLY CONFORM TO

DIMENSIONS SHOWN HEREON.

6" BELOW GRADE.

2. #5 REBAR ANCHOR TO EXTEND MIN.

CURB BACK OF WALK (AS

- TRANSITION CURB

NECESSARY)

