

## 377 SUMMER ST DAVIS SQ, SOMERVILLE, MA PROPOSED MIXED USE BUILDING



PLANNING COMMUNITY DESIGN

PETER QUINN ARCHITECTS LLC 1955 MASS AVE, SUITE 4 CAMBRIDGE, MA 02140 PH 617-354-3989 FAX 617-868-0280

CONSULTANT STERED ARCHITECTURE IN O. 7510 C. AMBRIDGE MA. TH OF MASSING.

377 SUMMER ST

377 SUMMER ST SOMERVILLE, MA

PREPARED FOR

CHRISTOS POUTAHIDIS 147 WILLOW AVE SOMERVILLE, MA 02144

DRAWING TITE

SCALE AS NOTED

REVISION / ISSUE DATE		
SP REV#2	26 MAR 200	
ISD SUBMISSION	07 NOV 200	
DRAWN BY	REVIEWED BY	
SH	PQ	

SHEET



VIEW FROM CITIZEN BANK BUILDING (EAST)



VIEW ACROSS CUTTER SQ (NORTH)

ARCHITECTURE
PLANNING
COMMUNITY DESIGN

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CONSULTANT

377 SUMMER ST 377 SUMMER ST SOMERVILLE, MA

PREPARED FOR

CHRISTOS POUTAHIDIS **147 WILLOW AVE** SOMERVILLE, MA 02144


## PROPOSED 3D VIEWS

SCALE AS NOTED

REVISION / ISSUE DATE

REV TO CONTEXT 15 MAY 2009 SP REV #2 26 MAR 2009

ISD SUBMISSION 07 NOV 2008

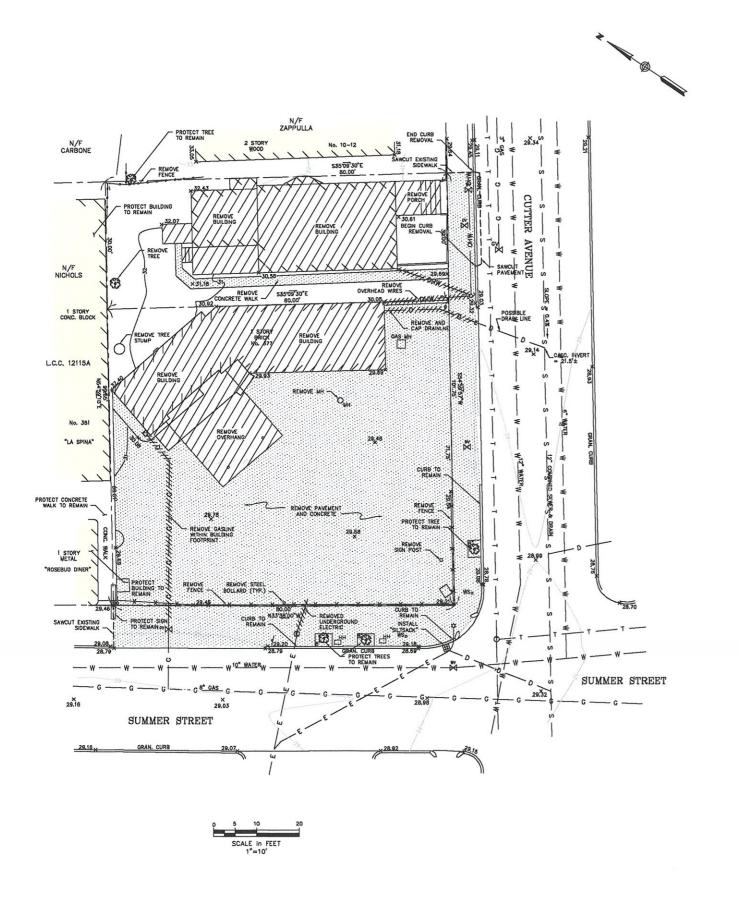



#### LEGEND

- - PROPERTY LINE COMBINED SEWER & DRAIN TELEPHONE
GAS ---- WATER OHW ---- OVERHEAD WIRE EXISTING CONTOUR WATER VALVE GV M → &@ ■ O

GAS VALVE SIGN LIGHT POLE CATCH BASIN TELEPHONE MANHOLE WALK SIGNAL HAND HOLE EXISTING SPOT ELEVATION


EXISTING BUILDINGS TO REMAIN

### SITE DEMOLITION NOTES:

ANY EXISTING WORK OR PROPERTY DAMAGED OR DISRUPTED BY CONSTRUCTION /DEWOLITION ACTIVITIES SHALL BE REPLACED OR REPAIRED TO MATCH ORIGINAL EXISTING CONDITIONS BY THE CONTRACTOR AT NO ADDITIONAL COST TO THE OWNER.

11. ANY WORK WITHIN SUMMER STREET AND CUTTER AVENUE RIGHT OF WAY TO BE COORDINATED WITH THE CITY OF SOMERVILLE

12. COORDINATE GAS AND ELECTRIC DEMOLITION WITH UTILITY COMPANIES.

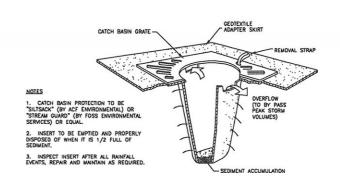

INLET PROTECTION BARRIER

### SITE REDEVELOPMENT

CHRISTOS POUTAHIDIS 147 WILLOW AVENUE SOMERVILLE, MA

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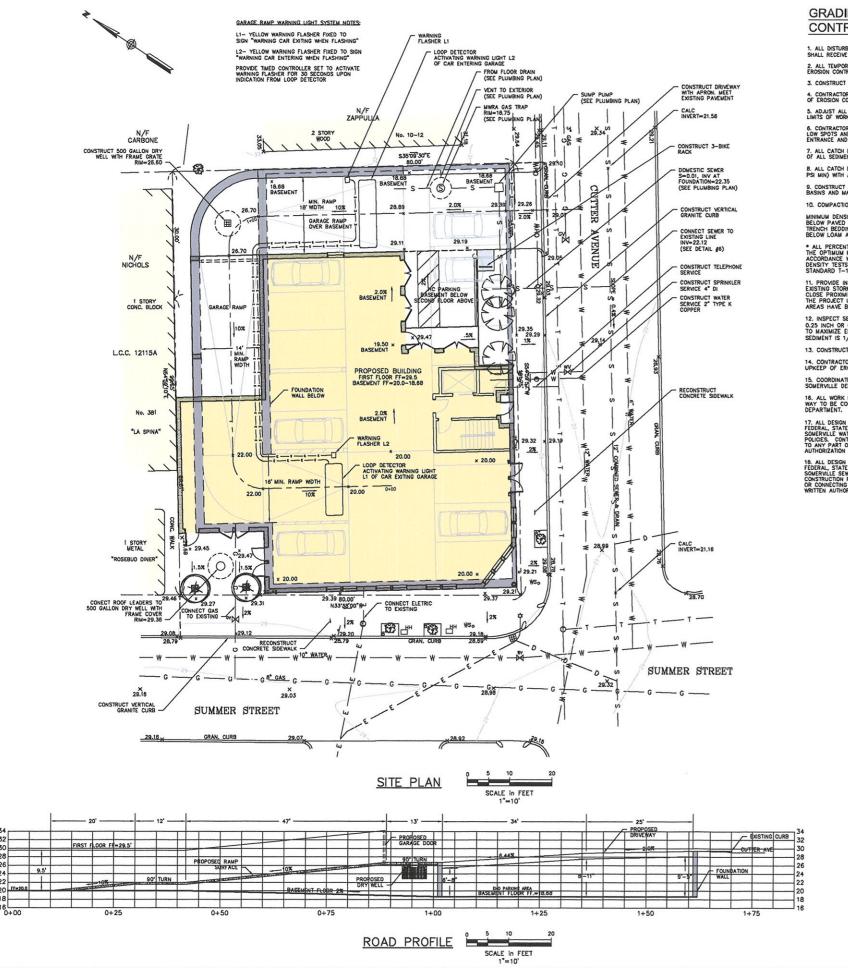


Brown's Whorf Newburyport, MA 01950 Tel. (978) 465-9877 Fax (978) 465-2986 www.ookengineers.com

### **EXISTING CONDITIONS/ DEMOLITION PLAN**

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+			-
No.	Revisi	on/Issue	Dote
Design by: SBS Drown by: SMT		Checked by: S Approved by:	BS BS
Project: 084158		December	R 29, 200
Sheet:			

C1




#### GRADING, DRAINAGE & EROSION **CONTROL NOTES:**

- ALL DISTURBED AREAS NOT TO BE PAVED OR OTHERWISE TREATED SHALL RECEIVE 4" LOAM, FERTILIZER,
- 2. ALL TEMPORARY LOAM STOCKPILES SHALL RECEIVE TEMPORARY EROSION CONTROL MEASURES.
- 3. CONSTRUCT RIP-RAP ON ALL SLOPES STEEPER THAN 2:1.
- CONTRACTOR SHALL BE RESPONSIBLE FOR MAINTENANCE AND UPKEEP OF EROSION CONTROL MEASURES.
- 5. ADJUST ALL MANHOLES, CATCH BASINS, CURB BOXES, ETC. WITHIN LIMITS OF WORK TO FINISH GRADE.
- 7. ALL CATCH BASINS AND DRAIN LINES SHALL BE THOROUGHLY CLEANED OF ALL SEDIMENT AND DEBRIS
- 8. ALL CATCH BASINS & MANHOLES SHALL BE PRECAST CONCRETE (4,000 PSI MIN) WITH AN INSIDE DIAMETER OF FOUR (4) FEET.
- 9. CONSTRUCT A MINIMUM OF  $6^{\circ}$  Crushed stone under all catch basins and manifoles,
- MINIMUM DENSITY\*
  BELOW PAYED OR CONCRETE AREAS
  TRENCH BEDDING MATERIAL AND SAND BLANKET BACKFILL
  BELOW LOAM AND SEED AREAS
- \* ALL PERCENTAGES SHALL BE OF THE MAXIMUM DRY DENSITY AT THE OPTIMUM MOISTURE CONTENT AS DETERMINED AND CONTROLLED IN ACCORDANCE WITH AMSITO STANDARD 180, METHOD C. FIELD DENSITY TESTS SHALL BE MADE IN ACCORDANCE WITH AASHTO STANDARD T-191, T-204, OR T-228 AND T-239.
- 11. PROVIDE INLET PROTECTION BARRIERS AROUND PROPOSED AND EXISTING STORM DRAINAGE NILETS WITHIN THE WORK LIMITS AND INCOSE PROXIMITY TO WORK AREAS, MAINTAIN FOR THE DURATION OF THE PROJECT UNTIL PAVEMENT HAS BEEN INSTALLED AND UPSTREAM AREAS HAVE BEEN STABILIZED.
- 13. CONSTRUCT RIP-RAP ON ALL SLOPES STEEPER THAN 2:1.
- 14. CONTRACTOR SHALL BE RESPONSIBLE FOR MAINTENANCE AND UPKEEP OF EROSION CONTROL MEASURES.
- 15. COORDINATE WATER AND SEWER CONNECTIONS WITH THE CITY OF SOMERVILLE DEPARTMENT OF PUBLIC SERVICES.
- 17. ALL DISON AND CONSTRUCTION OF ALL WHITE UTILITIES MUST MET FEBERAL SINT AND COS SANDARDS ON THE LITEST ARREN OF SOMERNILE WATER MOKES CONSTRUCTION CUBELINES AND CONSTRUCTION POLICIES. CONTRACTORS ARE PROHIBITED FROM O
- 18. ALL DESIGN AND CONSTRUCTION OF ALL SEWER UTILITIES MUST MEET FORMAL, STATE AND LOCAL STANDARDS AND THE LITEST VERSION OF CONSTRUCTION POLICIES. CONTRACTIONS ARE PROMISTICE FROM OPERATING OR CONNECTING TO ANY PART OF THE EXISTING SEWER SYSTEM WITHOUT WRITTEN AUTHORIZATION AND FILED OVERSIONED 18 THE SEWER DEPARTMENT.





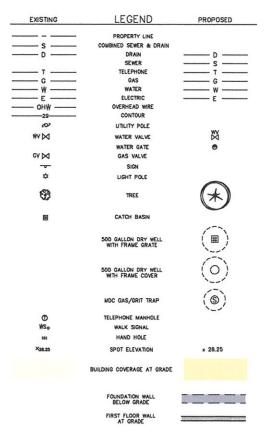





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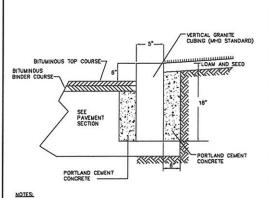
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SITE GRADING DRAINAGE AND UTILITIES DI ANI

No.	Revisi	on/Issue	Dote
Design	SBS	Checked by:	BS
Drown	by: SMT	Approved by:	SBS
Project 084		Dete: DECEMBE	R 29, 200



2. ALL RADII 50' AND SMALLER TO BE CONSTRUCTED USING CURVED SECTIONS.



R.O.W. LINE


5 TYPICAL WATER SERVICE

- CURB BOX 2-PIECE SCREW TYPE

- FINISHED GRADE

TYPE K COPPER -

SERVICE LINE

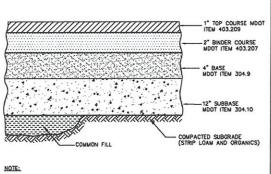

1. SEE SITE PLAN FOR PAVEMENT WIDTH AND LOCATION.

FOR SERVICES 1 1/2" AND LARGER, USE BRASS 22 1/2" BEND WITH COMPRESSION COUPLING TO SERVICE LINE.

MAIN SIZE

SQUARE FEET OF CONCRETE THRUST
BLOCKING BEARING ON UNDISTURBED MATERIAL

REACTION PIPE SIZE
TYPE 4" 6" 8" 10" 12"

ON BENDS AND TEES, EXTEND THRUST BLOCKS FULL LENGTH OF FITTING.

WHERE M.J. PIPE IS USED, M.J. PLUG WITH RETAINER GLAND MAY BE SUBSTITUTED FOR END BLOCKINGS.


PLACE BOARD IN FRONT OF ALL PLUGS BEFORE POURING THRUST BLOCKS.

0.89 2.19 3.82 11.14 17.24 0.65 1.55 2.78 8.38 12.00 0.48 1.19 2.12 6.02 9.32 0.25 0.80 1.06 3.09 4.74 0.13 0.30 0.54 1.54 2.38


MAXIMUM TAP SIZE WITHOUT SERVICE SADDLE

SEE GRADING, DRAINAGE AND EROSION CONTROL PLAN FOR PAVEWENT SLOPE AND CROSS-SLOPE.




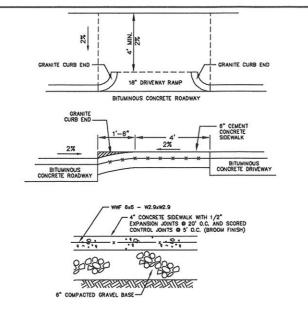



3 CONCRETE SIDEWALK/DRIVEWAY APRON

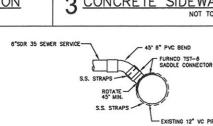


6 TYPICAL SEWER CONNECTION

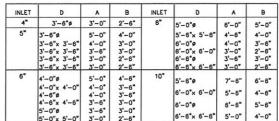


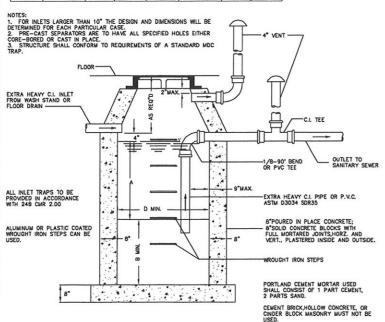


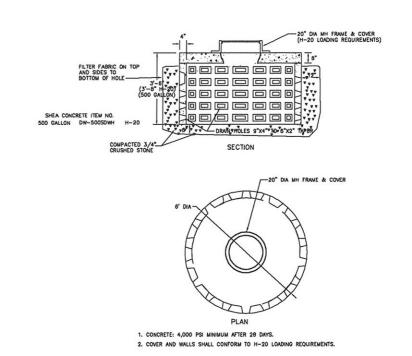


4 DRY WELL CYLINDRICAL 500 GALLON

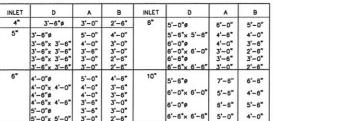

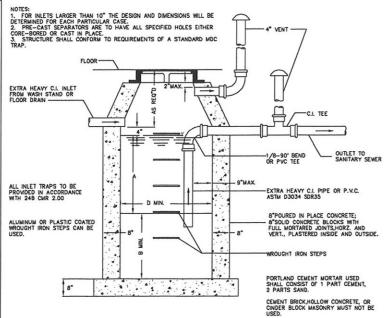

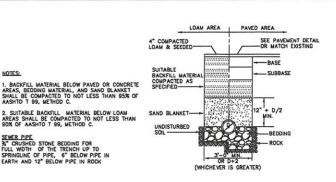

7 UTILITIES TRENCH

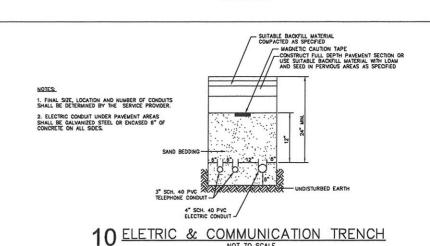

SITE REDEVELOPMENT CHRISTOS POUTAHIDIS 147 WILLOW AVENUE SOMERVILLE, MA

> 75. . . 29





**DETAILS** 

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No. Revisi		on/Issue	Dote
Dealign by: SBS  Drown by: SMT  Project: 084158		Approved by:	BS BS
		Dote:	R 29, 20


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8 THRUST BLOCKS

9 MDC TRAP DETAIL

NOT TO SCALE

1ST FL LANDSCAPE AREA HATCHED AREA = 752.2 SF

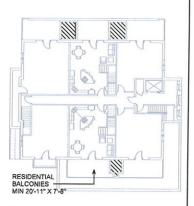


3RD FL LANDSCAPE AREA HATCHED AREA = 138.6 SF

LANDSCAPE CALCULATION

SCALE 1:28


TOTAL AREA = 890.8 SF

(11%) - PER SOMERVILLE ZONING BY-LAW DEFINITION

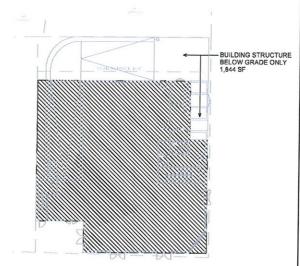


R GROUND COVERAGE CALCULATION SCALE 1:20


GROUND COVERAGE = 5,778 SF (71.7%) - PER SOMERVILLE ZONING BY-LAW DEFINITION

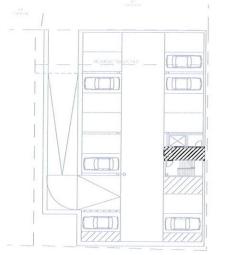

BLDG AREA - BASEMENT / PARKING HATCHED AREA = 120 SF

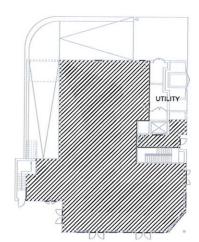


BLDG AREA - 1ST FLOOR HATCHED AREA = 4,214 SF

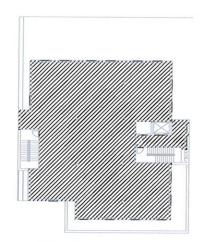


BLDG AREA - 2ND FLOOR HATCHED AREA = 4,510.5 SF


BASEMENT / PKG	120 SF
1ST FLOOR	4,214 SF
2ND FLOOR	4,510.5 SF
3RD FLOOR	3,537 SF
4TH FLOOR	3,608 SF
TOTAL	15,989.5 SF

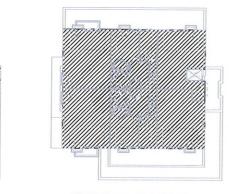

BLDG AREA - 4TH FLOOR HATCHED AREA = 3,608 SF



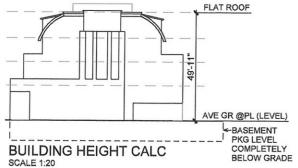

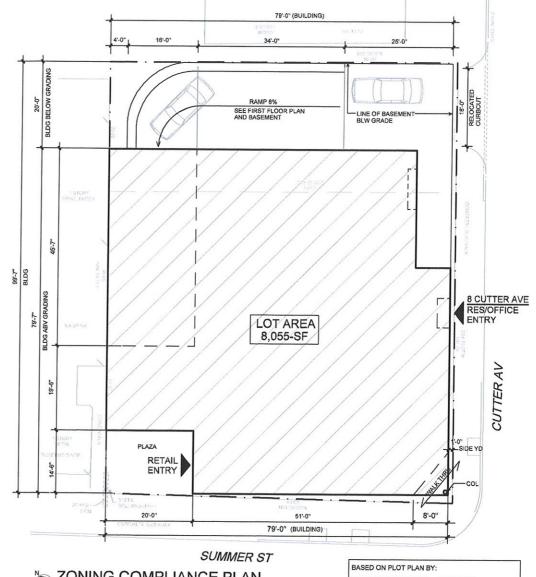

NOTICE PLAN SCALE = 1:10

MEDFORD ENGINEERING & SURVEY 15 HALL ST MEDFORD, MA 02155 PH. (781) 396-4466 FAX (781) 396-8052 DATE: NOVEMBER 2, 2007

#### **377 SUMMER STREET** DIMENSIONAL TABLE - CBD ZONING DISTRICT - SPSR APPLICATION

MAX FLR AREA RATIO         2.0 (MAX ALI           TOTAL ALLOWABLE BLDG AREA (EXCL GAR'S & BSMT)         LOT AREA X           GROUND COVERAGE         80.0% (MAX           MIN LANDSCAPED AREA         10.0% (MIN F           MAX HT FT - STORIES         50.07 4-STY           MIN FRONT YD         NA           MIN SIDE YD - LEFT - RIGHT         NA           MIN REAR YD         10.0° PLUS 2           MIN FRONTAGE         NA	2.0 = 16,110 SF		1.98	F SF/UNIT	COMPLIES
MAX FLR AREA RATIO         2.0 (MAX AL'           TOTAL ALLOWABLE BLDG AREA (EXCL GAR'S & BSMT)         LOT AREA X           GROUND COVERAGE         80.0% (MAX           MIN LANDSCAPED AREA         10.0% (MIN R           MAX HTFT - STORIES         50.07 4-STY           MIN FRONT YD         NA           MIN SIDE YD - LEFT - RIGHT         NA           MIN REAR YD         10.0° PLUS 2           MIN FRONTAGE         NA           PARKING REQUIREMENTS         UNITS 1-5 2 BDRM 1.5 SPACES NEG WIFER WITT-RIGHT ROW           REQUIREMENTS         REFAUL LEVEL PARKING ROW	VD) 2.0 = 16,110 SF		1.98	SF/UNIT	COMPLIES
TOTAL ALLOWABLE BLDG AREA (EXCL GAR'S & BSMT)  GROUND COVERAGE  MIN LANDSCAPED AREA  10.0% (MIN F MAX HTFT - STORIES  50.07 4-STY  MIN FRONT YD  MIN SIDE YD - LEFT - RIGHT  MIN REAR YD  MIN FRONTAGE  PARKING REQUIREMENTS  REFAIL LEVEL PARKING ROW  (EXCL CAREA AND THE STAND TH	2.0 = 16,110 SF				
(EXCL GAR'S & BSMT)           GROUND COVERAGE         80.0% (MAX           MIN LANDSCAPED AREA         10.0% (MIN B           MAX HT FT - STORIES         50.07 4-STY           MIN FRONT YD         NA           MIN SIDE YD - LEFT - RIGHT         NA           MIN REAR YD         10.0° PLUS 2           MIN FRONTAGE         NA           PARKING REQUIREMENTS         UNITS 1-8.2 BDRM 1.5 SPACES NEQ WIPER WITT           REQUIREMENTS         RFFAIL LEVEL PARKING ROW				1.98	
MIN LANDSCAPED AREA  MAX HT FT - STORIES  50.07 4-STY  MIN FRONT YD  MIN SIDE YD - LEFT	ALWD)		15,989.	5 SF	COMPLIES
MAX HT FT - STORIES         50.07 4-STY           MIN FRONT YD         NA           MIN SIDE YD - LEFT - RIGHT         NA           MIN REAR YD         10.0° PLUS 2           MIN FRONTAGE         NA           PARKING REQUIREMENTS         UNITS 1-8.2 BDRM - STAR CONTROLLED TO THE PARKING ROM           REQUIREMENTS         RFFAIL LEVEL PARKING ROM		GROUND COVERAGE 80.0% (MAX ALWD) 71.7%, SEE NOTE 1		COMPLIES	
MIN FRONT YD NA MIN SIDE YD - LEFT NA - RIGHT NA MIN REAR YD 10.0° PLUS 2 MIN FRONTAGE  PARKING REQUIREMENTS RETAIL LEVEL PARKING ROW	QD)	(	11%,	E CALCULATION	COMPLIES
MIN SIDE YD - LEFT NA	50.074-STY 49-11"/4-		/4-STY	COMPLIES	
- RIGHT NA MIN REAR YD 10.0° PLUS 2 MIN FRONTAGE  PARKING REQUIREMENTS RETAIL LEVEL PARKING ROM RETAIL LEVEL PARKING ROM RETAIL LEVEL PARKING ROM		0.0'		COMPLIES	
MIN FRONTAGE  PARKING REQUIREMENTS RETAIL LEVEL PARKING RQM			0.0° 0.9°		COMPLIES
PARKING UNITS 1-6. 2 BDRM 1.5 SPACES REQUIPER VAIT RETAIL LEVEL PARKING ROM	10.0' PLUS 2' FOR EACH STY ABV GROUND FL		20.0', ABV BSMT LVL		COMPLIES
PARKING REQUIREMENTS  1.5 SPACES REQUIPER VNIT	NA		79.0		COMPLIES
OFFICE LEVEL PARKING RQM (4,906 GSF / 575 GSF =  NOTAL PARKING RQMT (LESS 20% PROPOSED SP RED RECID PARKING	(RETAIL SALES ASSUMED)	9.3 8.5 27.8 (3.56)		NOTE 1 - GROUI CALCULATION E OF BELOW GRA GARAGE (1,844	EXCLUDES AREA DE PARKING

15 SPACES



ARCHITECTURE PLANNING COMMUNITY DESIGN

PETER QUINN ARCHITECTS LLC 1955 MASS AVE, SUITE 4 CAMBRIDGE, MA 02140 PH 617-354-3989 FAX 617-868-0280

CONSULTANT

377 SUMMER ST

377 SUMMER ST SOMERVILLE, MA

PREPARED FOR

CHRISTOS POUTAHIDIS 147 WILLOW AVE SOMERVILLE, MA 02144

### ZONING COMPLIANCE

SCALE AS NOTED

REVISION / ISSUE DATE


SP REV#2 26 MAR 2009 SP REVISION 13 MAR 2009 ISD SUBMISSION 07 NOV 2008

SH

BLDG AREA - 3RD FLOOR HATCHED AREA = 3,537 SF

TOTAL AREA: 15,939.5 SF PER SOMERVILLE DEFINTION OF NET FLOOR AREA



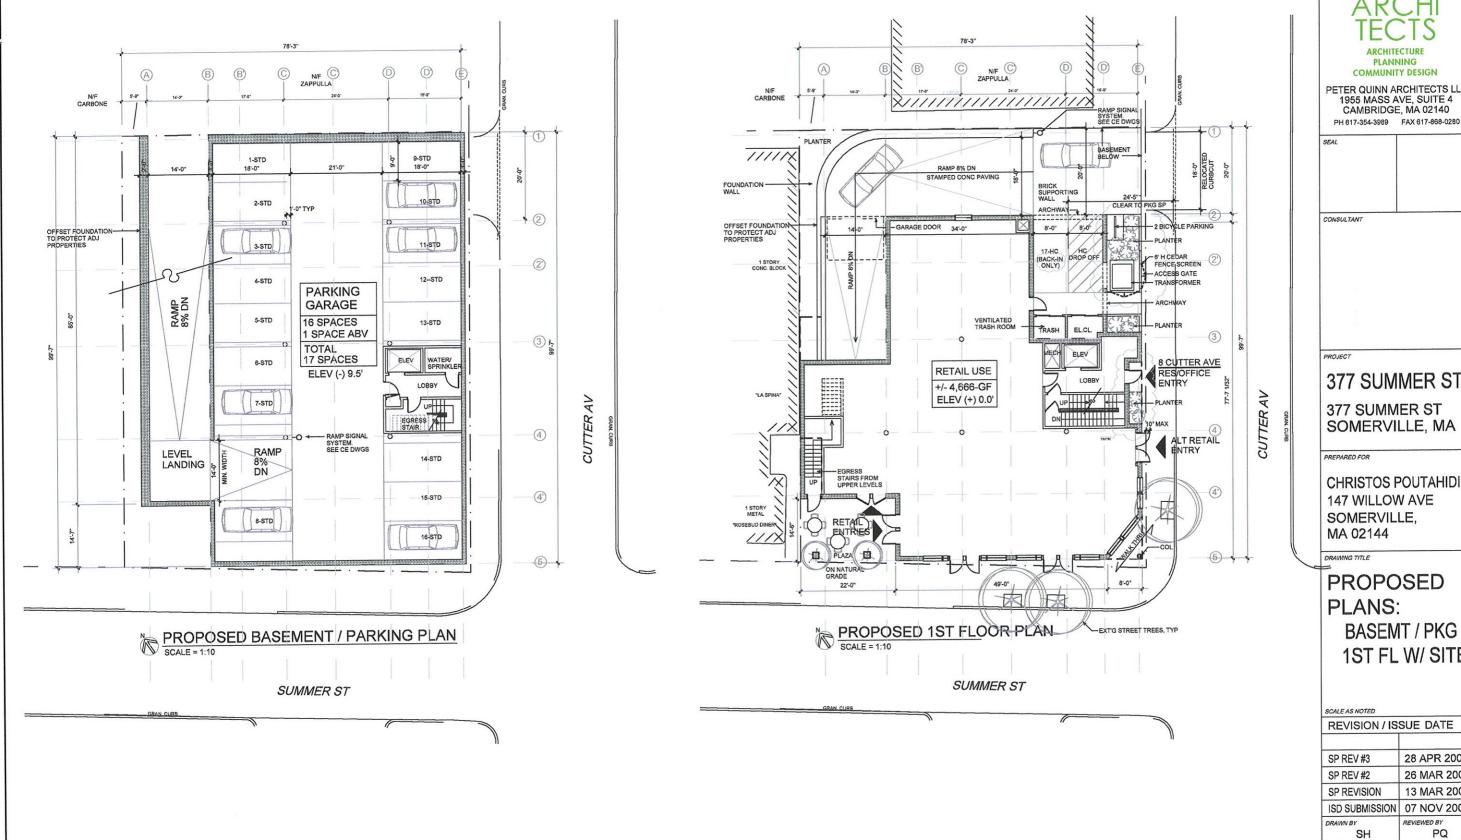

**PETER** 

**PLANNING COMMUNITY DESIGN** 

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377 SUMMER ST


377 SUMMER ST SOMERVILLE, MA


CHRISTOS POUTAHIDIS 147 WILLOW AVE SOMERVILLE,

PROPOSED BASEMT / PKG 1ST FL W/ SITE


REVISION / ISSUE DATE		
28 APR 2009		
26 MAR 2009		
13 MAR 2009		
07 NOV 2008		
REVIEWED BY		



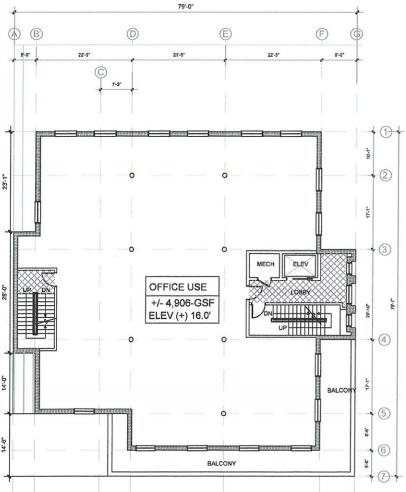

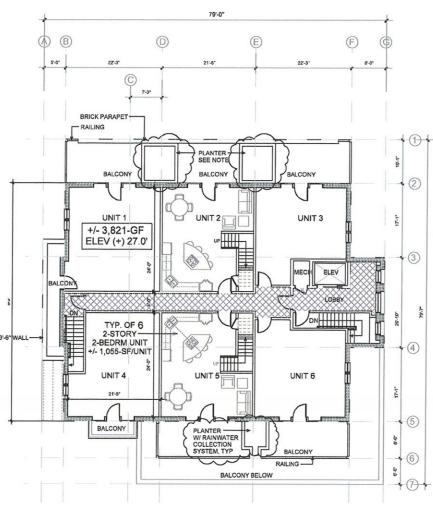



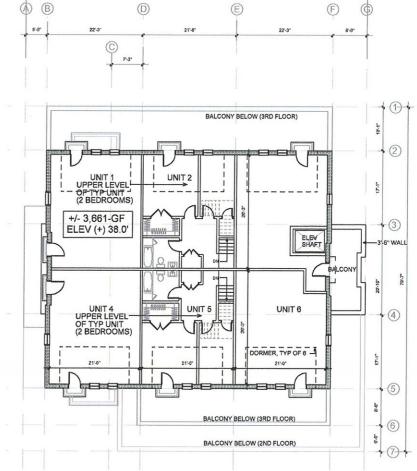

PROPOSED 4TH FLOOR LEVEL
SCALE = 1:10

79'-0"

PLANNING

PETER QUINN ARCHITECTS LLC 1955 MASS AVE, SUITE 4 CAMBRIDGE, MA 02140 PH 617-354-3989 FAX 617-868-0280

COMMUNITY DESIGN

CONSULTANT

PROJECT

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377 SUMMER ST SOMERVILLE, MA

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**CHRISTOS POUTAHIDIS** 147 WILLOW AVE SOMERVILLE, MA 02144


**PROPOSED** PLANS: 2ND FL 3RD FL 4TH FL

SCALE AS NOTED

REVISION / ISSUE DATE SP REV#2 26 MAR 2009 SP REVISION 13 MAR 2009 ISD SUBMISSION 07 NOV 2008 SH PQ SHEET

PROPOSED 2ND FLOOR LEVEL
SCALE = 1:10



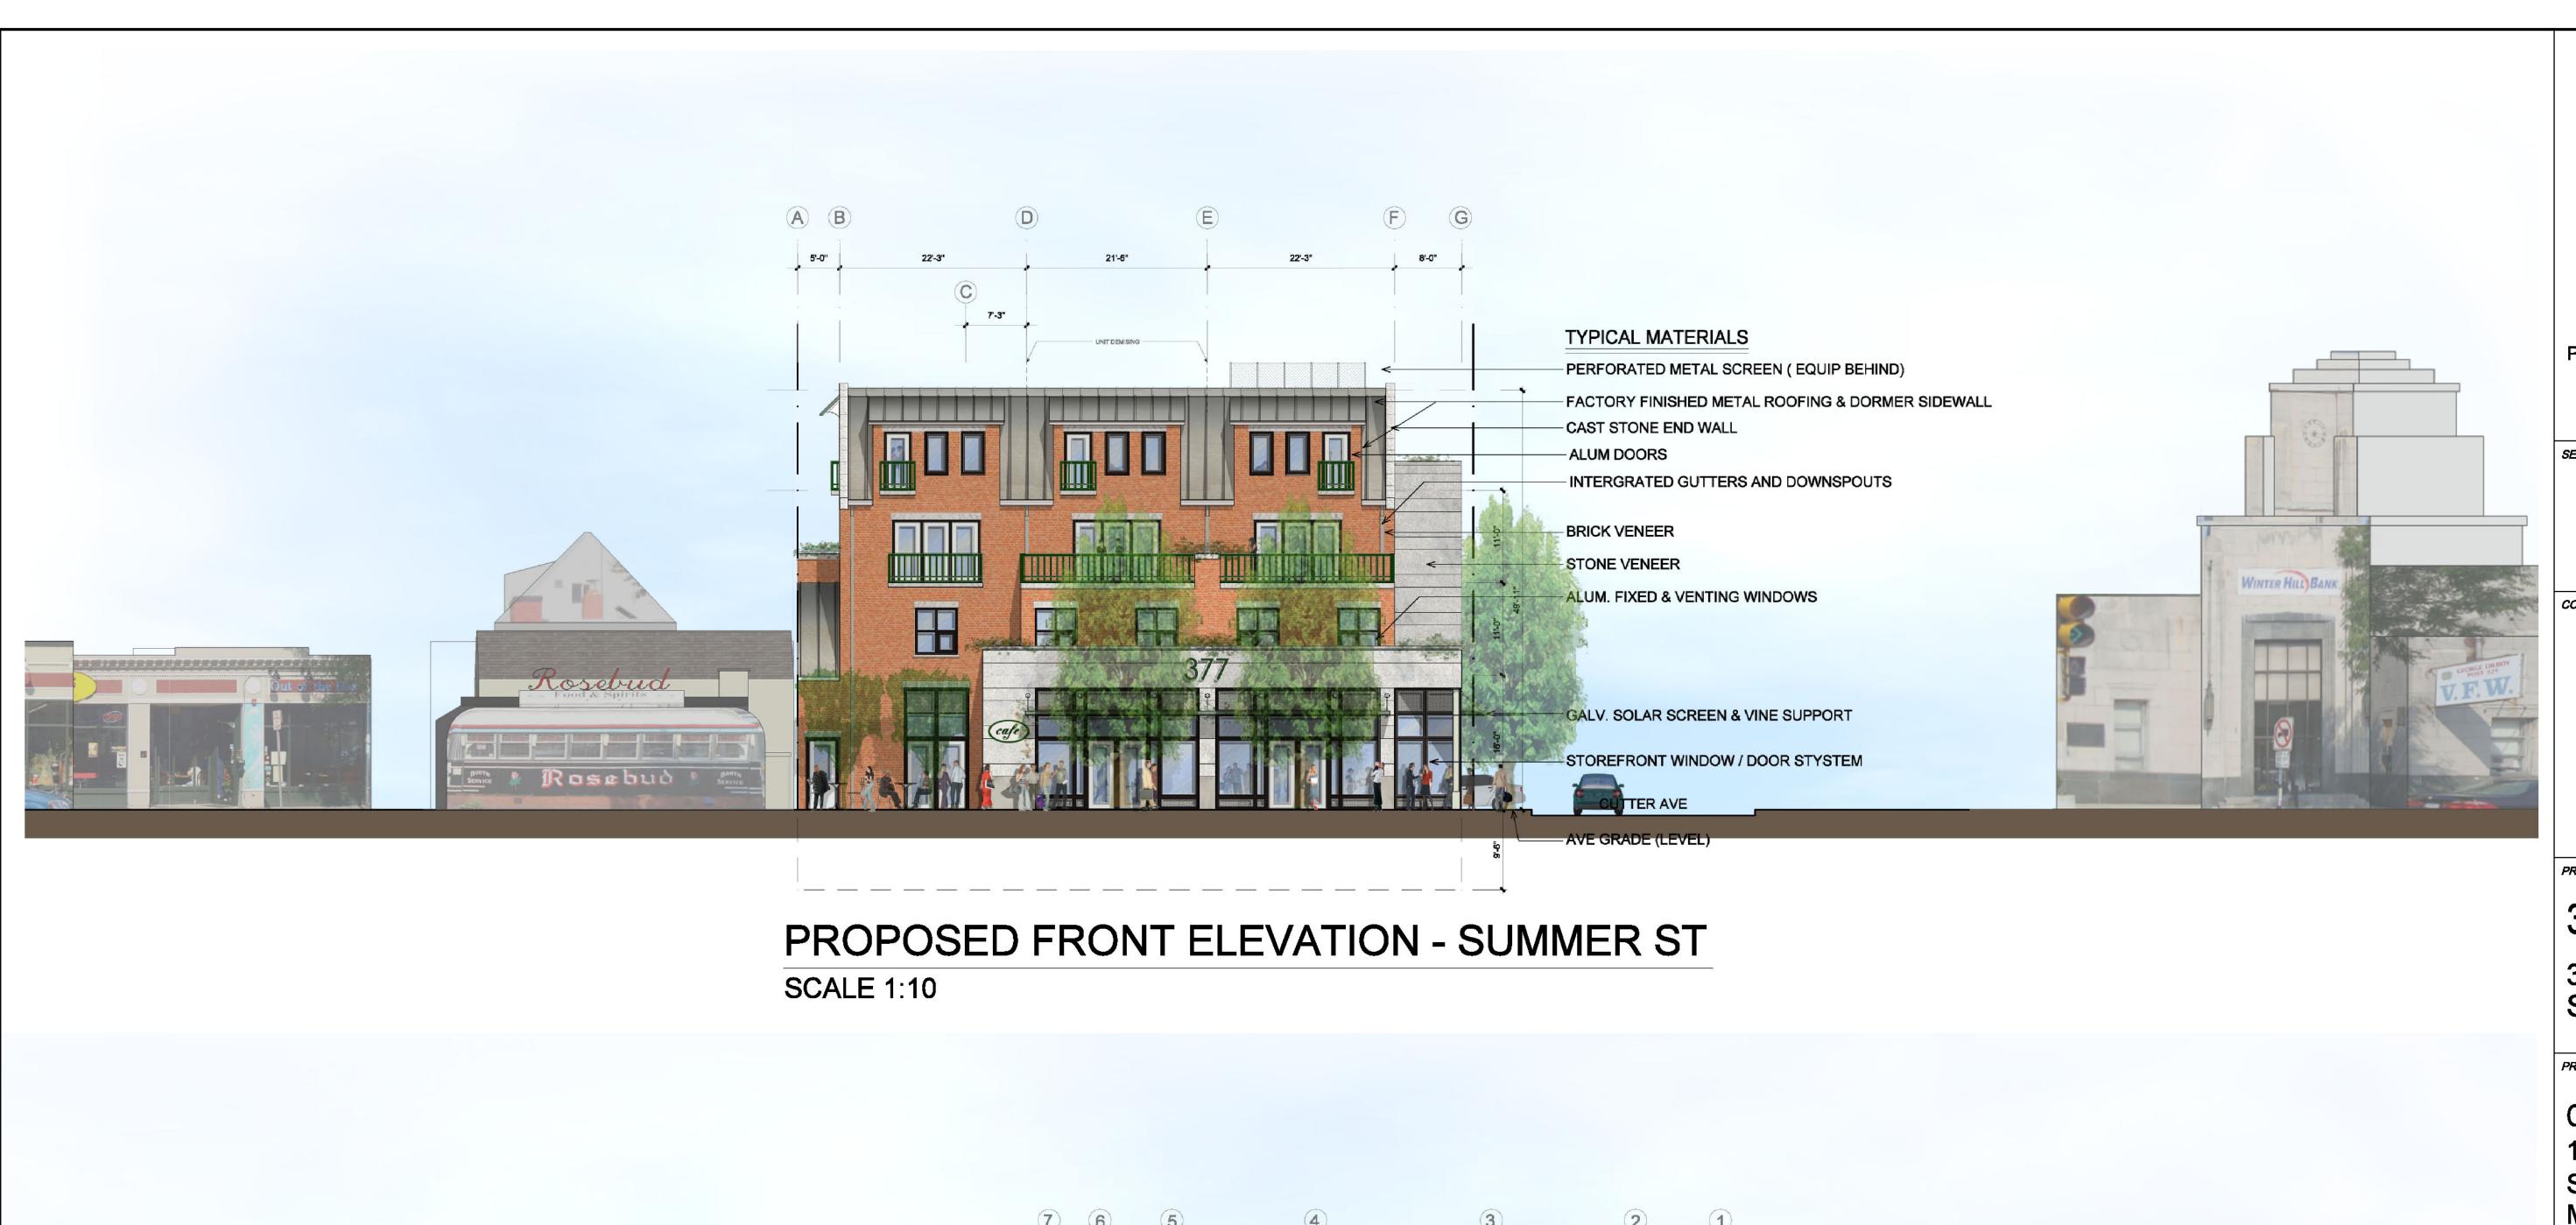



PROPOSED RIGHT ELEVATION - CUTTER AVE

SCALE 1:10

# PETER QUINN ARCHI TECTS

PLANNING COMMUNITY DESIGN

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CONSULTANT

PROJEC

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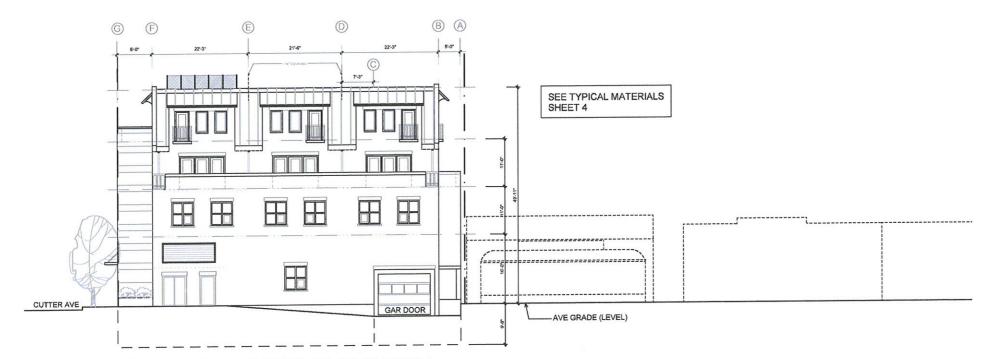
DRAWING TITE

## PROPOSED ELEVATIONS

SCALE AS NOTED

REVISION / ISSUE DATE		
REV TO CONTEXT	15 MAY 2009	
SP REV #3	28 APR 2009	
SP REV #2	26 MAR 2009	
SP REVISION	13 MAR 2009	
ISD SUBMISSION	07 NOV 2008	
DRAWN BY	REVIEWED BY	
SH	PQ	

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## PROPOSED REAR ELEVATION

SCALE 1:10



## PROPOSED LEFT ELEVATION

**SCALE 1:10** 

PETER
QUINN
ARCHI
TECTS

ARCHITECTURE
PLANNING
COMMUNITY DESIGN

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SEAL

CONSULTANT

PROJEC

## 377 SUMMER ST

SOMERVILLE, MA

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CHRISTOS POUTAHIDIS 147 WILLOW AVE SOMERVILLE, MA 02144

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